MASSACHUSETTS DEPARTMENT OF TRANSPORTATION HIGHWAY DIVISION

PROJECT FILE NO. 607571

PLAN AND PROFILE OF

CAPE COD RAIL TRAIL EXTENSION - PHASE II (BRIDGE NO. D-07-007 = Y-01-010 (BNH))

IN THE TOWNS OF


YARMOUTH & DENNIS BARNSTABLE COUNTY

FEDERAL AID PROJECT NO. STP/TIP-002S(958)X

AND THE LATEST EDITION OF THE AMERICAN STANDARD FOR NURSERY STOCK, WILL GOVERN

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SHEET NO.	DESCRIPTION
1	TITLE & INDEX SHEET
2	LEGEND, GENERAL NOTES & ABBREVIATIONS
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DESIGN DESIGNATION (CAPE COD RAIL TRAIL EXTENSION)

DESIGN SPEED FUNCTIONAL CLASSIFICATION

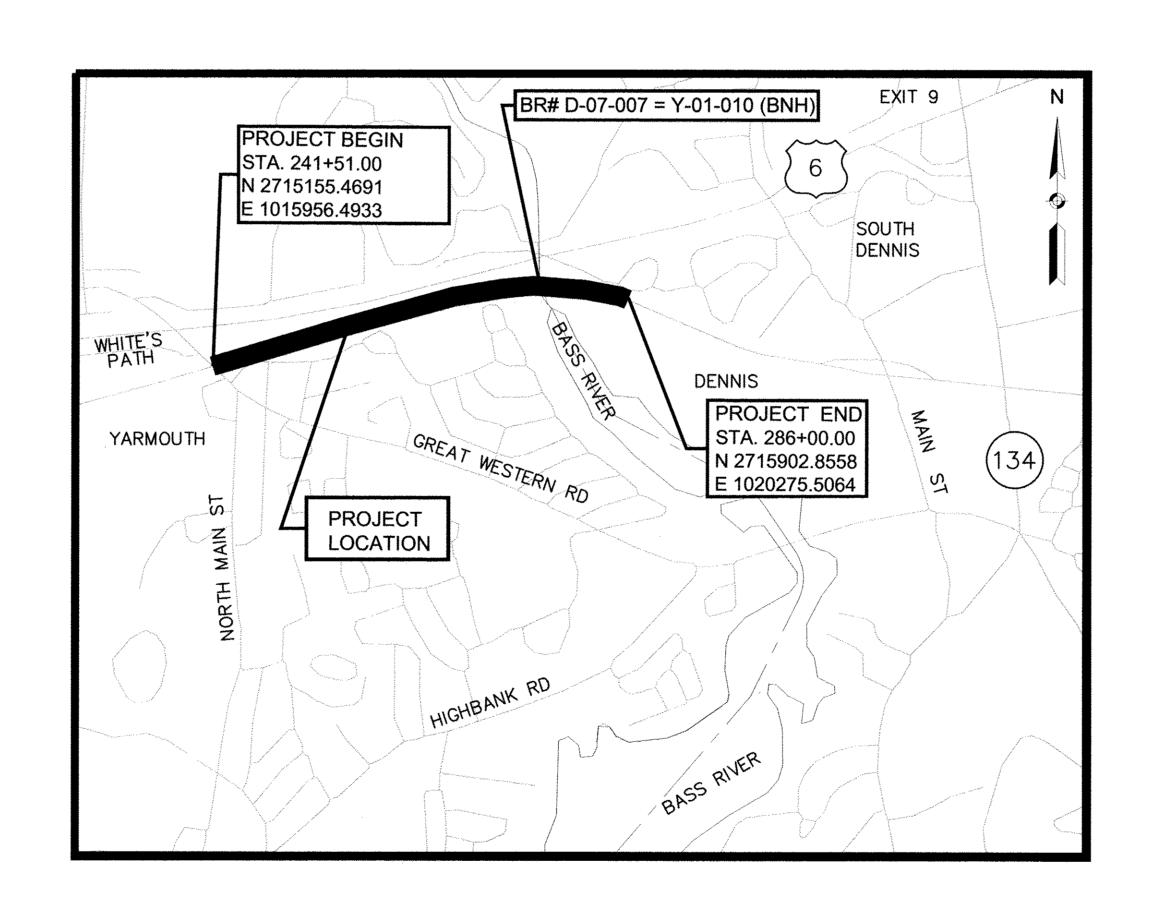SHARED USE PATH

DESIGN DESIGNATION (NORTH MAIN STREET)

DESIGN SPEED

FUNCTIONAL CLASSIFICATION

URBAN MINOR ARTERIAL


DESIGN DESIGNATION (WHITE'S PATH)

DESIGN SPEED


30 MPH


FUNCTIONAL CLASSIFICATION

URBAN MINOR ARTERIAL

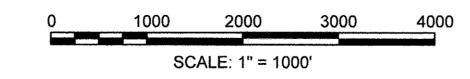

LENGTH OF PROJECT = 4,449.00 FEET = 0.843 MILES

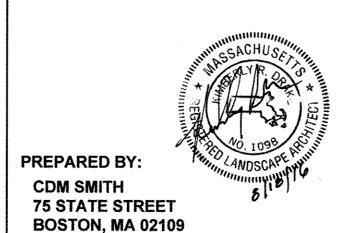


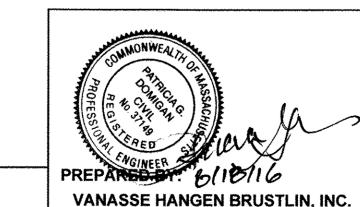

VANASSE HANGEN BRUSTLIN, INC. **101 WALNUT STREET** WATERTOWN, MA 02471

DEPARTMENT OF TRANSPORTATION FEDERAL HIGHWAY ADMINISTRATION APPROVED:

DIVISION ADMINISTRATOR DATE

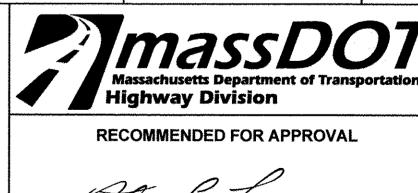

DESCRIPTION

CHIEF ENGINEER



PVI

PVC

PVT

PVRC

PVCC

SSD

POINT OF VERTICAL INTERSECTION

POINT OF VERTICAL REVERSE CURVE


POINT OF VERTICAL COMPOUND CURVE

POINT OF VERTICAL CURVE

STOPPING SIGHT DISTANCE

VERTICAL CURVE

POINT OF VERTICAL TANGENT

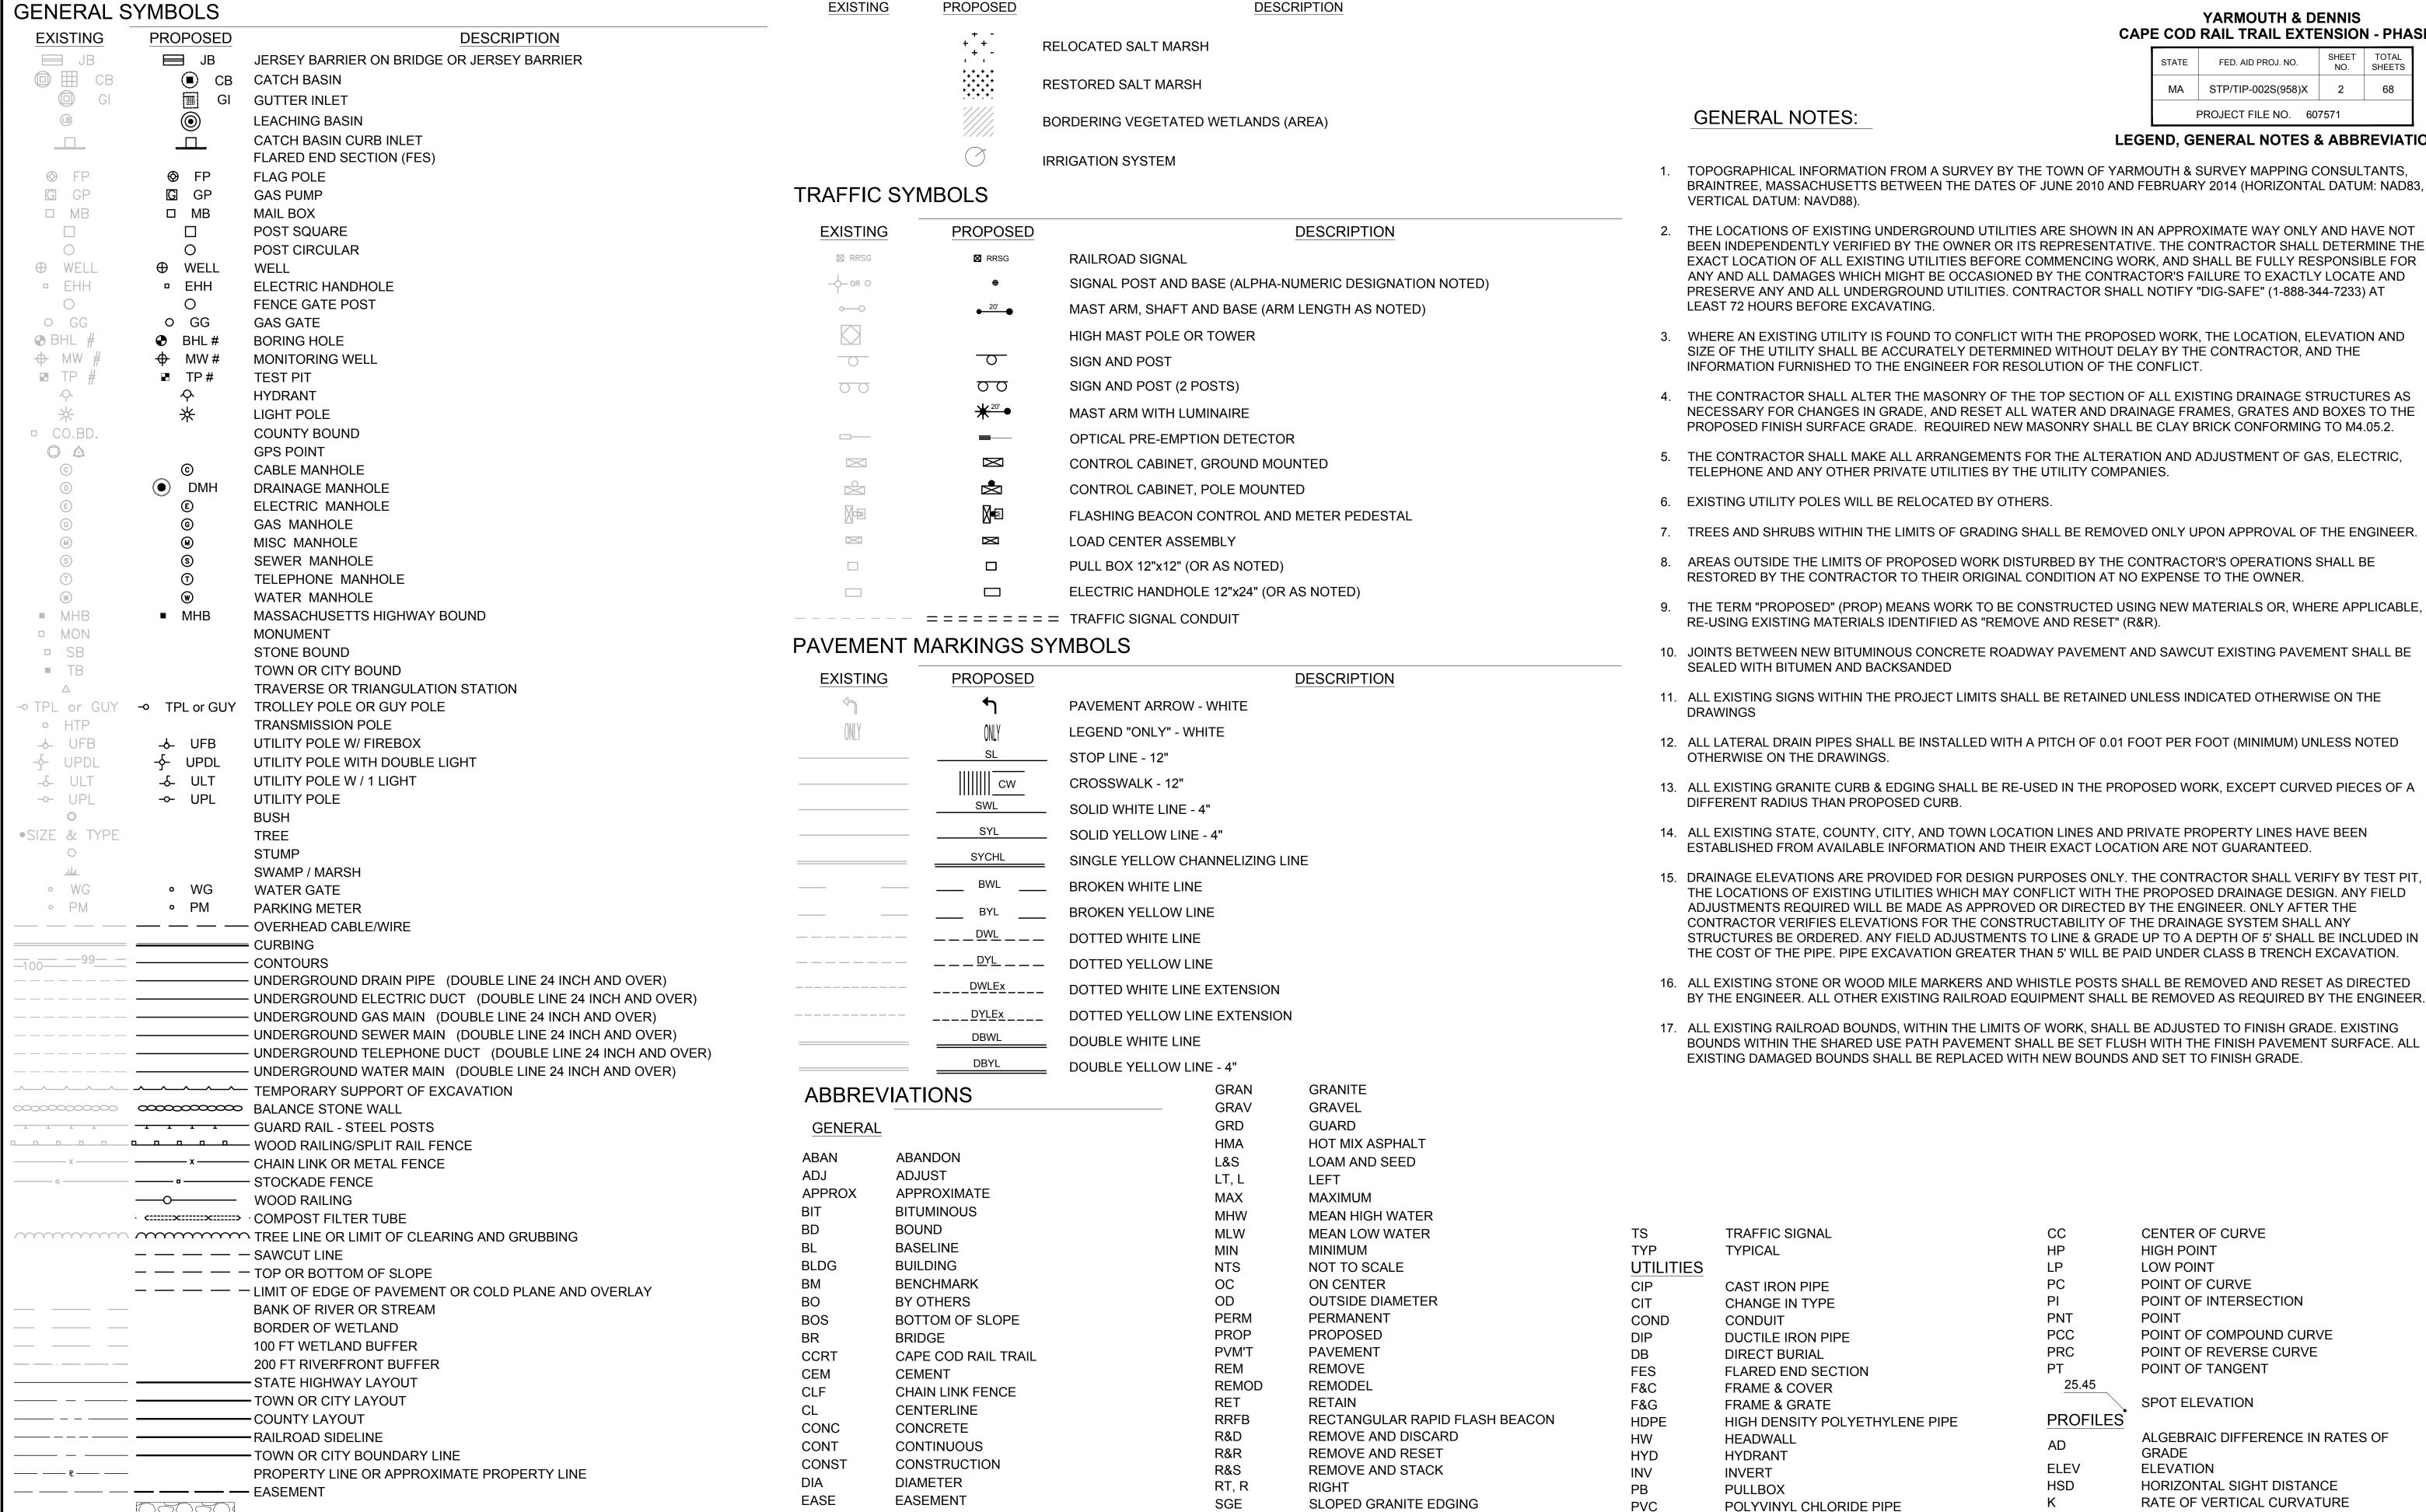

SHLDR

SYCHL

STA

SUP

TOB

TOS

TEMP

SHOULDER

TEMPORARY

TOP OF BANK

TOP OF SLOPE

SHARED USE PATH

STATION

SOLID YELLOW CHANNELIZED LINE

PWW

RCP

TSV&B

PAVED WATER WAY

BOTTOM OF CURB

UTILITY POLE

ALIGNMENT/GRADING

REINFORCED CONCRETE PIPE

TAPPING SLEEVE, VALVE, & BODY

ELEV (or EL) ELEVATION

EDGE OF PAVEMENT

EXISTING

EXTENSION

FOUNDATION

GATE POST

EOP

EXIST

EXT


FDN

GP

RIP RAP SLOPE TREATMENT

PROP MATTING FOR EROSION CONTROL

BOULDER

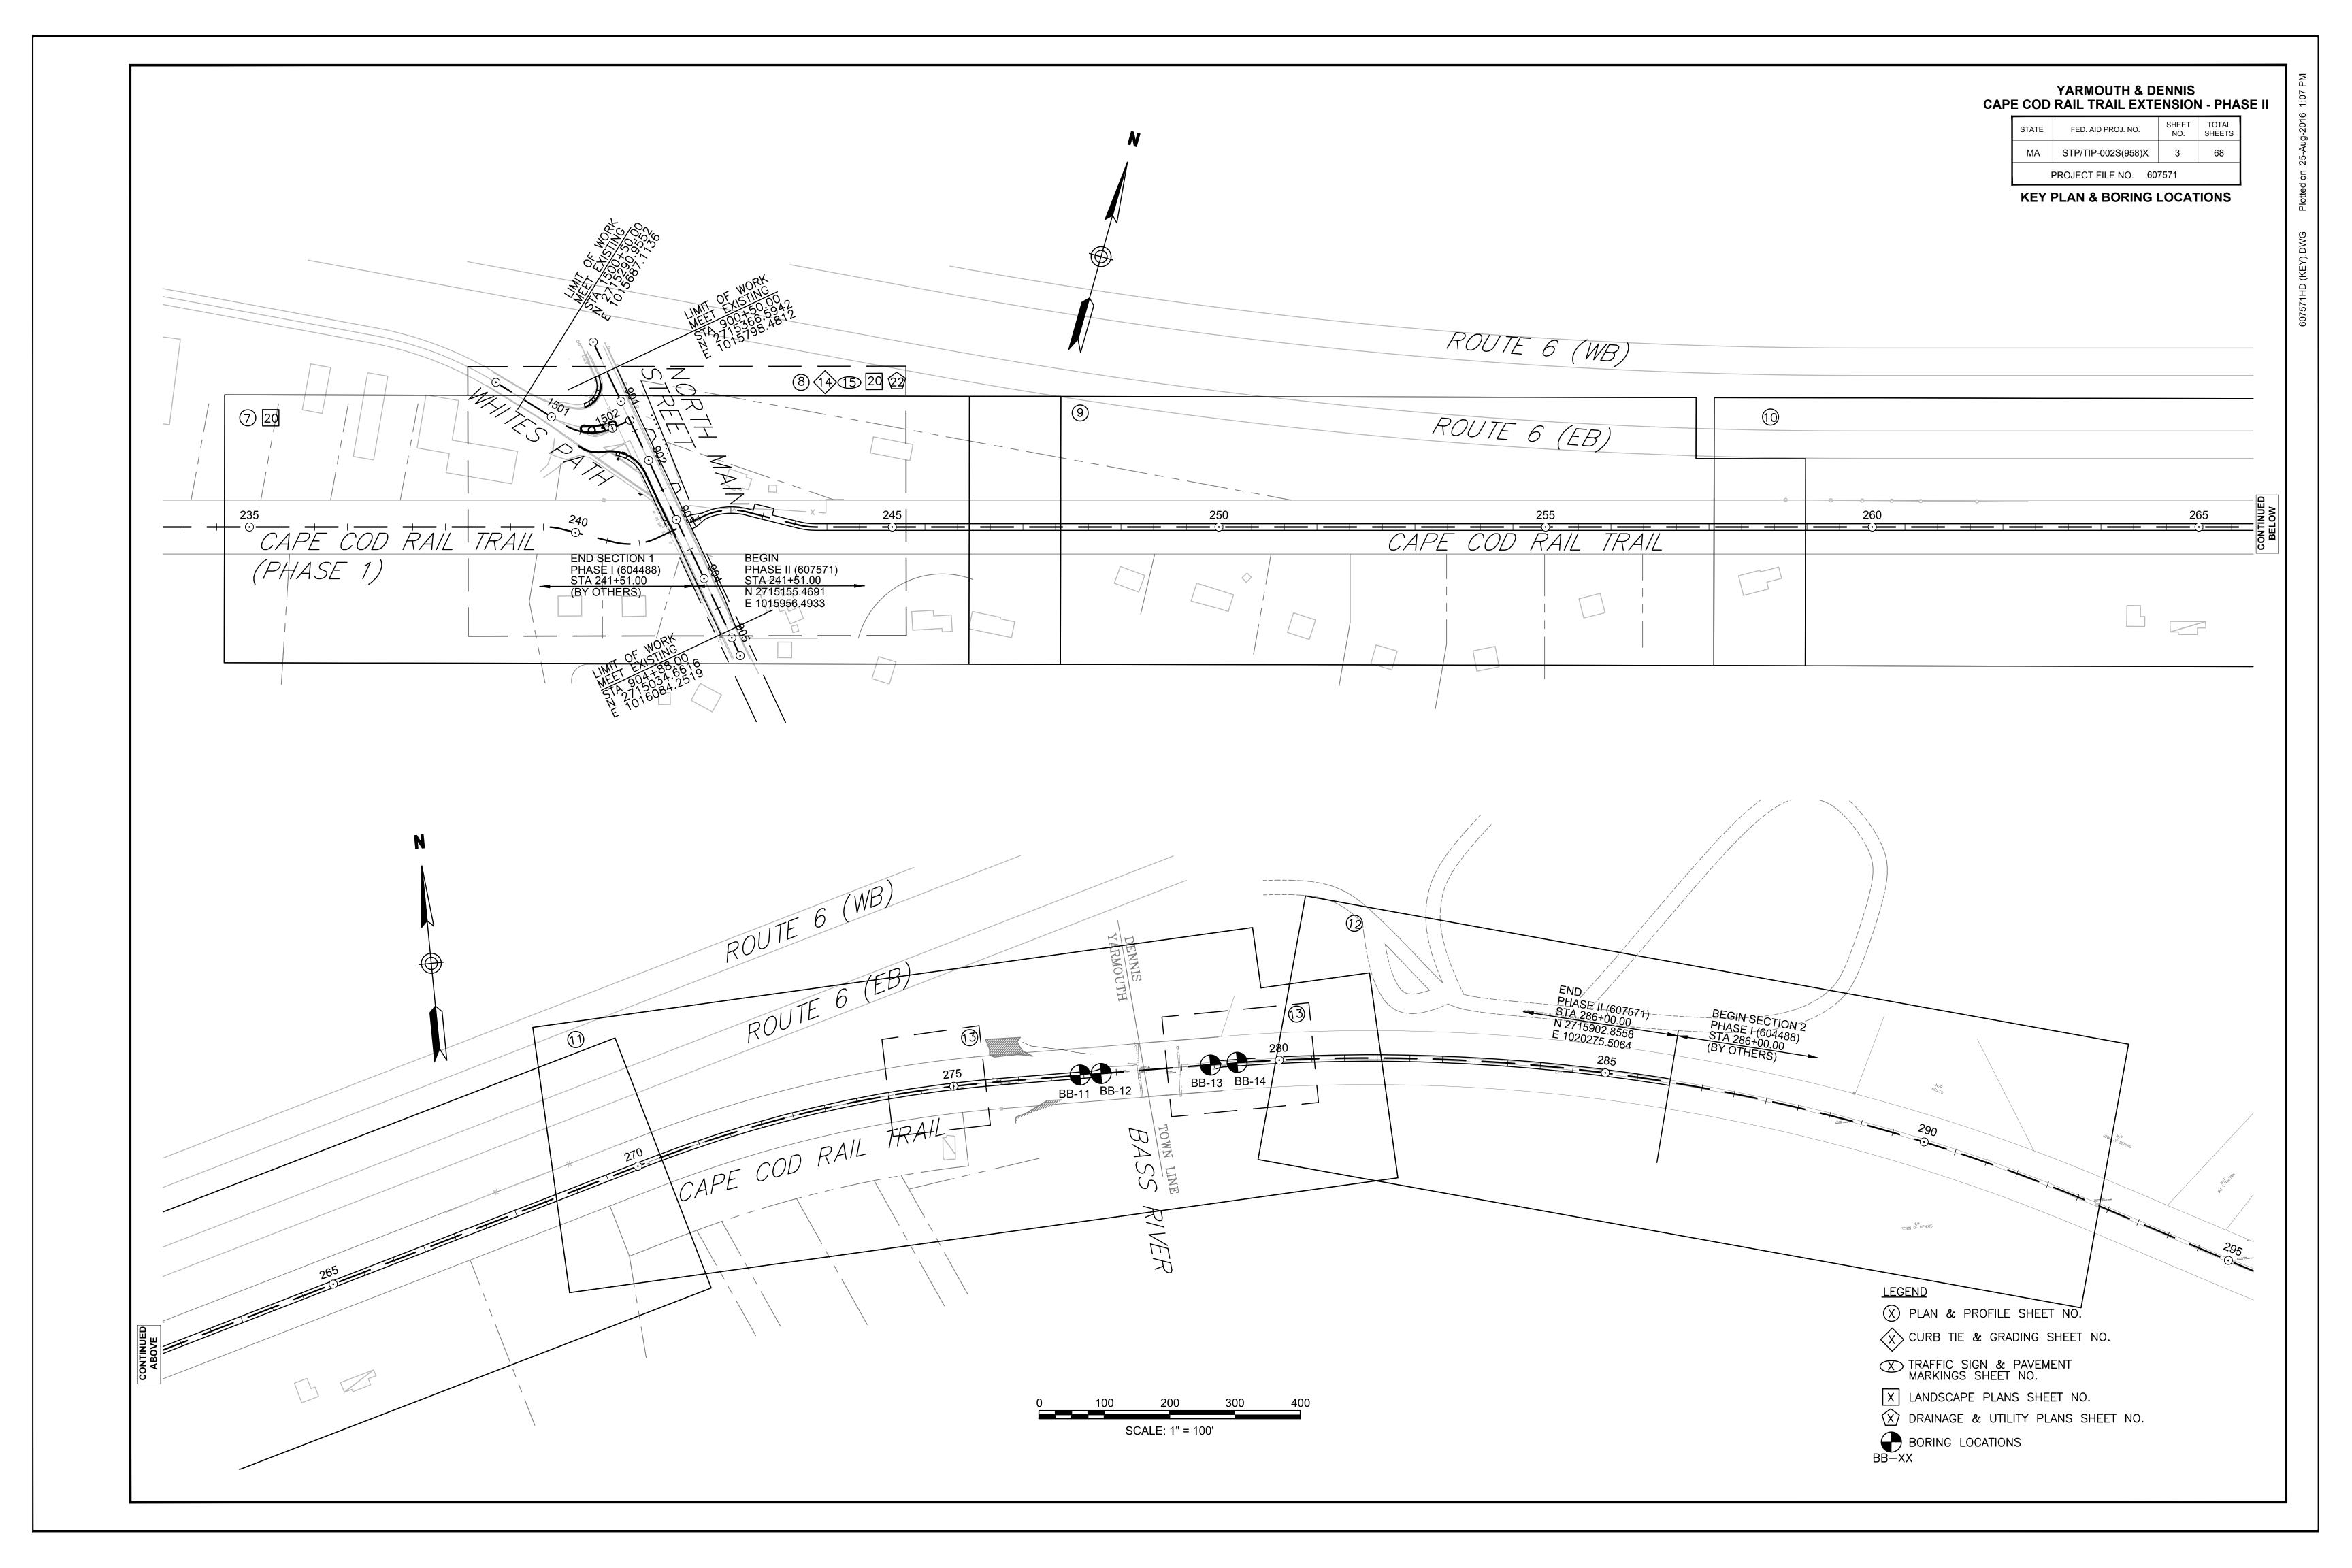

YARMOUTH & DENNIS CAPE COD RAIL TRAIL EXTENSION - PHASE I



TYPICAL SECTIONS & PAVEMENT NOTES

PAVEMENT NOTES

PROPOSED FULL DEPTH SHARED USE PATH (SUP) PAVEMENT

(ON EXISTING RAILROAD EMBANKMENT)

SURFACE: 1.5" SUPERPAVE SURFACE COURSE 9.5 (SSC-9.5) OVER

BASE: 2.5" SUPERPAVE INTERMEDIATE COURSE 19.0 (SIC-19.0)

SUBBASE: 4" GRAVEL BORROW, TYPE b

PROPOSED FULL DEPTH SHARED USE PATH PAVEMENT

(OFF EXISTING RAILROAD EMBANKMENT)

SURFACE: 1.5" SUPERPAVE SURFACE COURSE 9.5 (SSC-9.5) OVER

BASE: 2.5" SUPERPAVE INTERMEDIATE COURSE 19.0 (SIC-19.0)

SUBBASE: 12" GRAVEL BORROW, TYPE b

PROPOSED FULL DEPTH PAVEMENT

SURFACE: 1.5" SUPERPAVE SURFACE COURSE 9.5 (SSC-9.5) OVER 2.5" SUPERPAVE INTERMEDIATE COURSE 19.0 (SIC-19.0)

BASE: 4.0" SUPERPAVE BASE COURSE 37.5 (SBC-37.5)

SUBBASE: 4" DENSE GRADED CRUSHED STONE OVER

8" GRAVEL BORROW, TYPE b

PROPOSED FULL DEPTH PAVEMENT (LESS THAN 4.0' WIDE)

SURFACE: 1.5" SUPERPAVE SURFACE COURSE 9.5 (SSC-9.5) OVER 2.5" SUPERPAVE INTERMEDIATE COURSE 19.0 (SIC-19.0)

BASE: 8" HIGH EARLY STRENGTH CEMENT

CONCRETE BASE COURSE

SUBBASE: 8" GRAVEL BORROW, TYPE b

PROPOSED PAVEMENT MILLING AND OVERLAY

SURFACE: 1.5" SUPERPAVE SURFACE COURSE 9.5 (SSC-9.5) OVER

1.5" MAXIMUM PAVEMENT MICROMILLINĠ

LEVELING COURSE: VARIABLE DEPTH (1" MIN) SUPERPAVE LEVELING COURSE 9.5 (SLC-9.5)

ASPHALT EMULSION FOR TACK COAT AT 0.07 GAL/SY

PROPOSED HOT MIX ASPHALT DRIVEWAY

SURFACE: 1.5" SUPERPAVE SURFACE COURSE 9.5 (SSC-9.5) OVER

FOUNDATION: 8" GRAVEL BORROW, TYPE b

PROPOSED HOT MIX ASPHALT WALK/RAISED MEDIAN

SURFACE: 1.0" SUPERPAVE SURFACE COURSE 9.5 (SSC-9.5) OVER

1.5" SUPERPAVE INTERMEDIATE COURSE 12.5 (SIC-12.5)

2.0" SUPERPAVE INTERMEDIATE COURSE 12.5 (SIC-12.5)

FOUNDATION: 8" GRAVEL BORROW, TYPE b


PROPOSED CEMENT CONCRETE WHEELCHAIR RAMP/ISLAND/WALK

SURFACE: 4" CEMENT CONCRETE
AIR ENTRAINED 4000 PSI, 3/4", 610

FOUNDATION: 8" GRAVEL BORROW, TYPE b

PAVEMENT NOTES:


- ALL SUPERPAVE HOT MIX ASHALT SHALL BE A WARM MIX ASPHALT TECHNOLOGY.
- ASPHALT EMULSION FOR TACK COAT SHALL BE APPLIED AT 0.07 GALLONS PER SQUARE YARD TO MILLED SURFACES AND 0.05 GALLONS PER SQUARE YARD TO SMOOTH SURFACES PRIOR TO PAVING. HMA JOINT SEALANT SHALL BE APPLIED TO COLD JOINTS PRIOR TO PAVING.

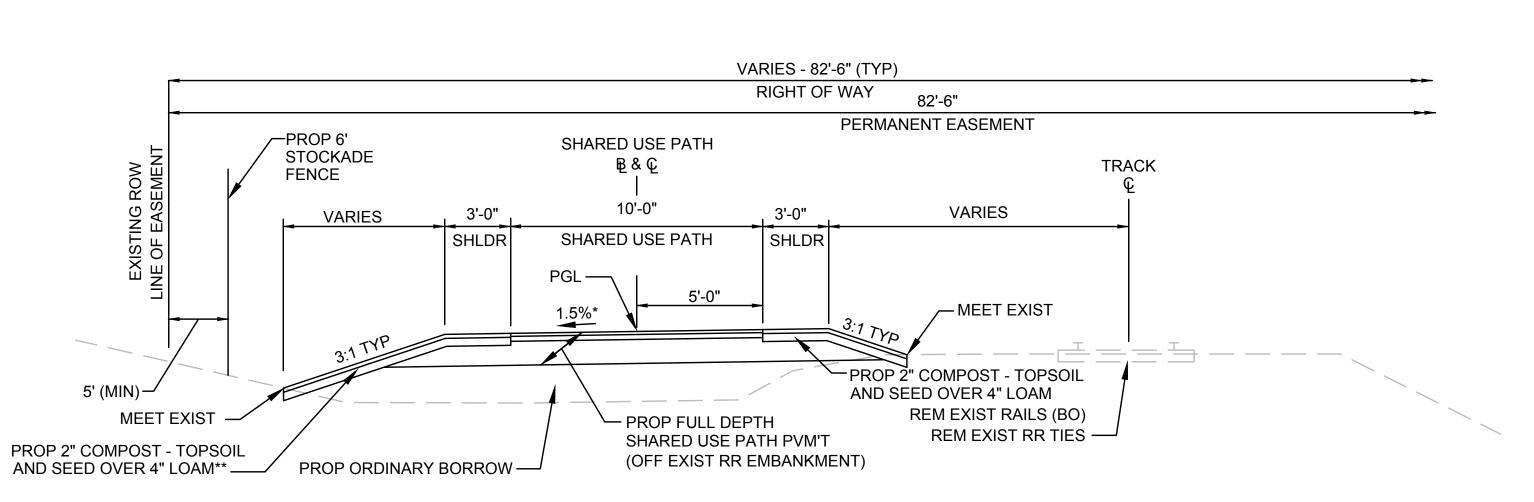

TYPICAL SHARED USE PATH SECTION

STA 242+00± TO STA 243+75± FULL WIDTH NORTH OF TRACK * 0.5% TOLERANCE FOR CONSTRUCTION

** SLOPE SEED MIX B1 SHALL BE USED ON ALL
SLOPES 3:1 AND STEEPER

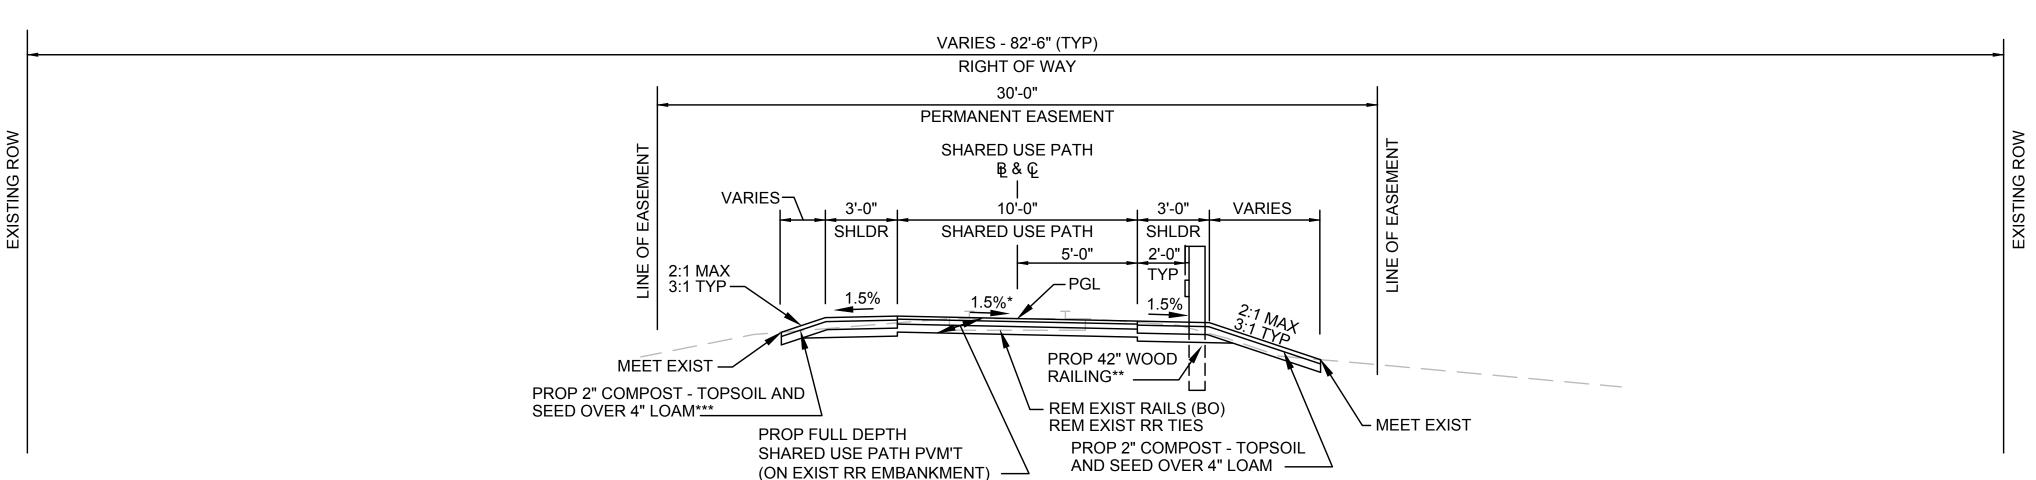


TYPICAL SHARED USE PATH SECTION

STA 243+75± TO STA 250+25± STA 266+75± TO STA 275+30± STA 279+50± TO STA 282+50± FULL WIDTH ON TRACK * 0.5% TOLERANCE FOR CONSTRUCTION

** PROP WOOD RAILING RT STA 279+40 TO 279+75, 281+88 TO 282+63


*** SLOPE SEED MIX B1 SHALL BE USED ON ALL
SLOPES 3:1 AND STEEPER

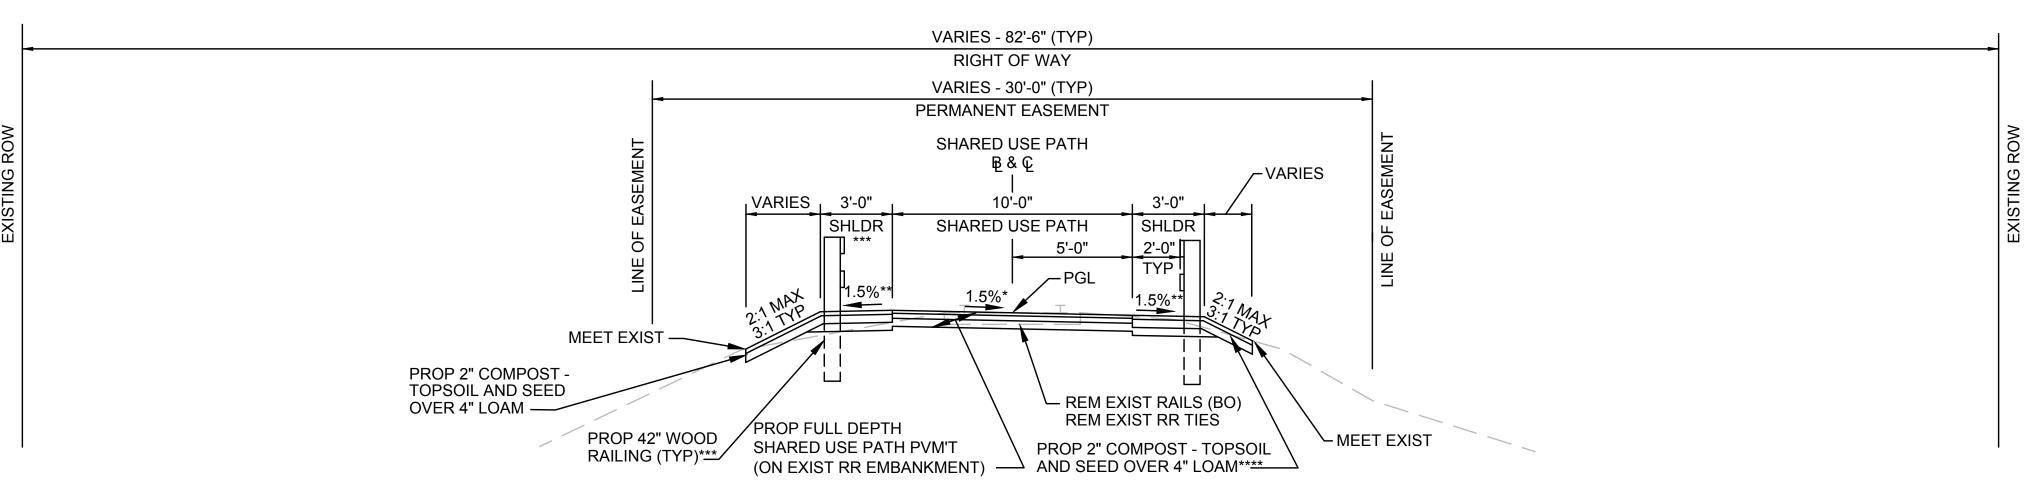



TYPICAL SHARED USE PATH SECTION


STA 250+25± TO STA 258+75± STA 263+00± TO STA 266+75± FULL WIDTH ON TRACK


- * 0.5% TOLERANCE FOR CONSTRUCTION
- ** 6:1 SLOPED SHOULDER STA 255+70 TO 257+10 LT/RT, 264+80 TO 265+15 RT
- *** PROP WOOD RAILING RT STA 252+65 TO 256+50, 264+00 TO 265+80 PROP WOOD RAILING LT STA 250+50 TO 258+25, 262+75 TO 268+70
- **** SLOPE SEED MIX B1 SHALL BE USED ON ALL SLOPES 3:1 AND STEEPER

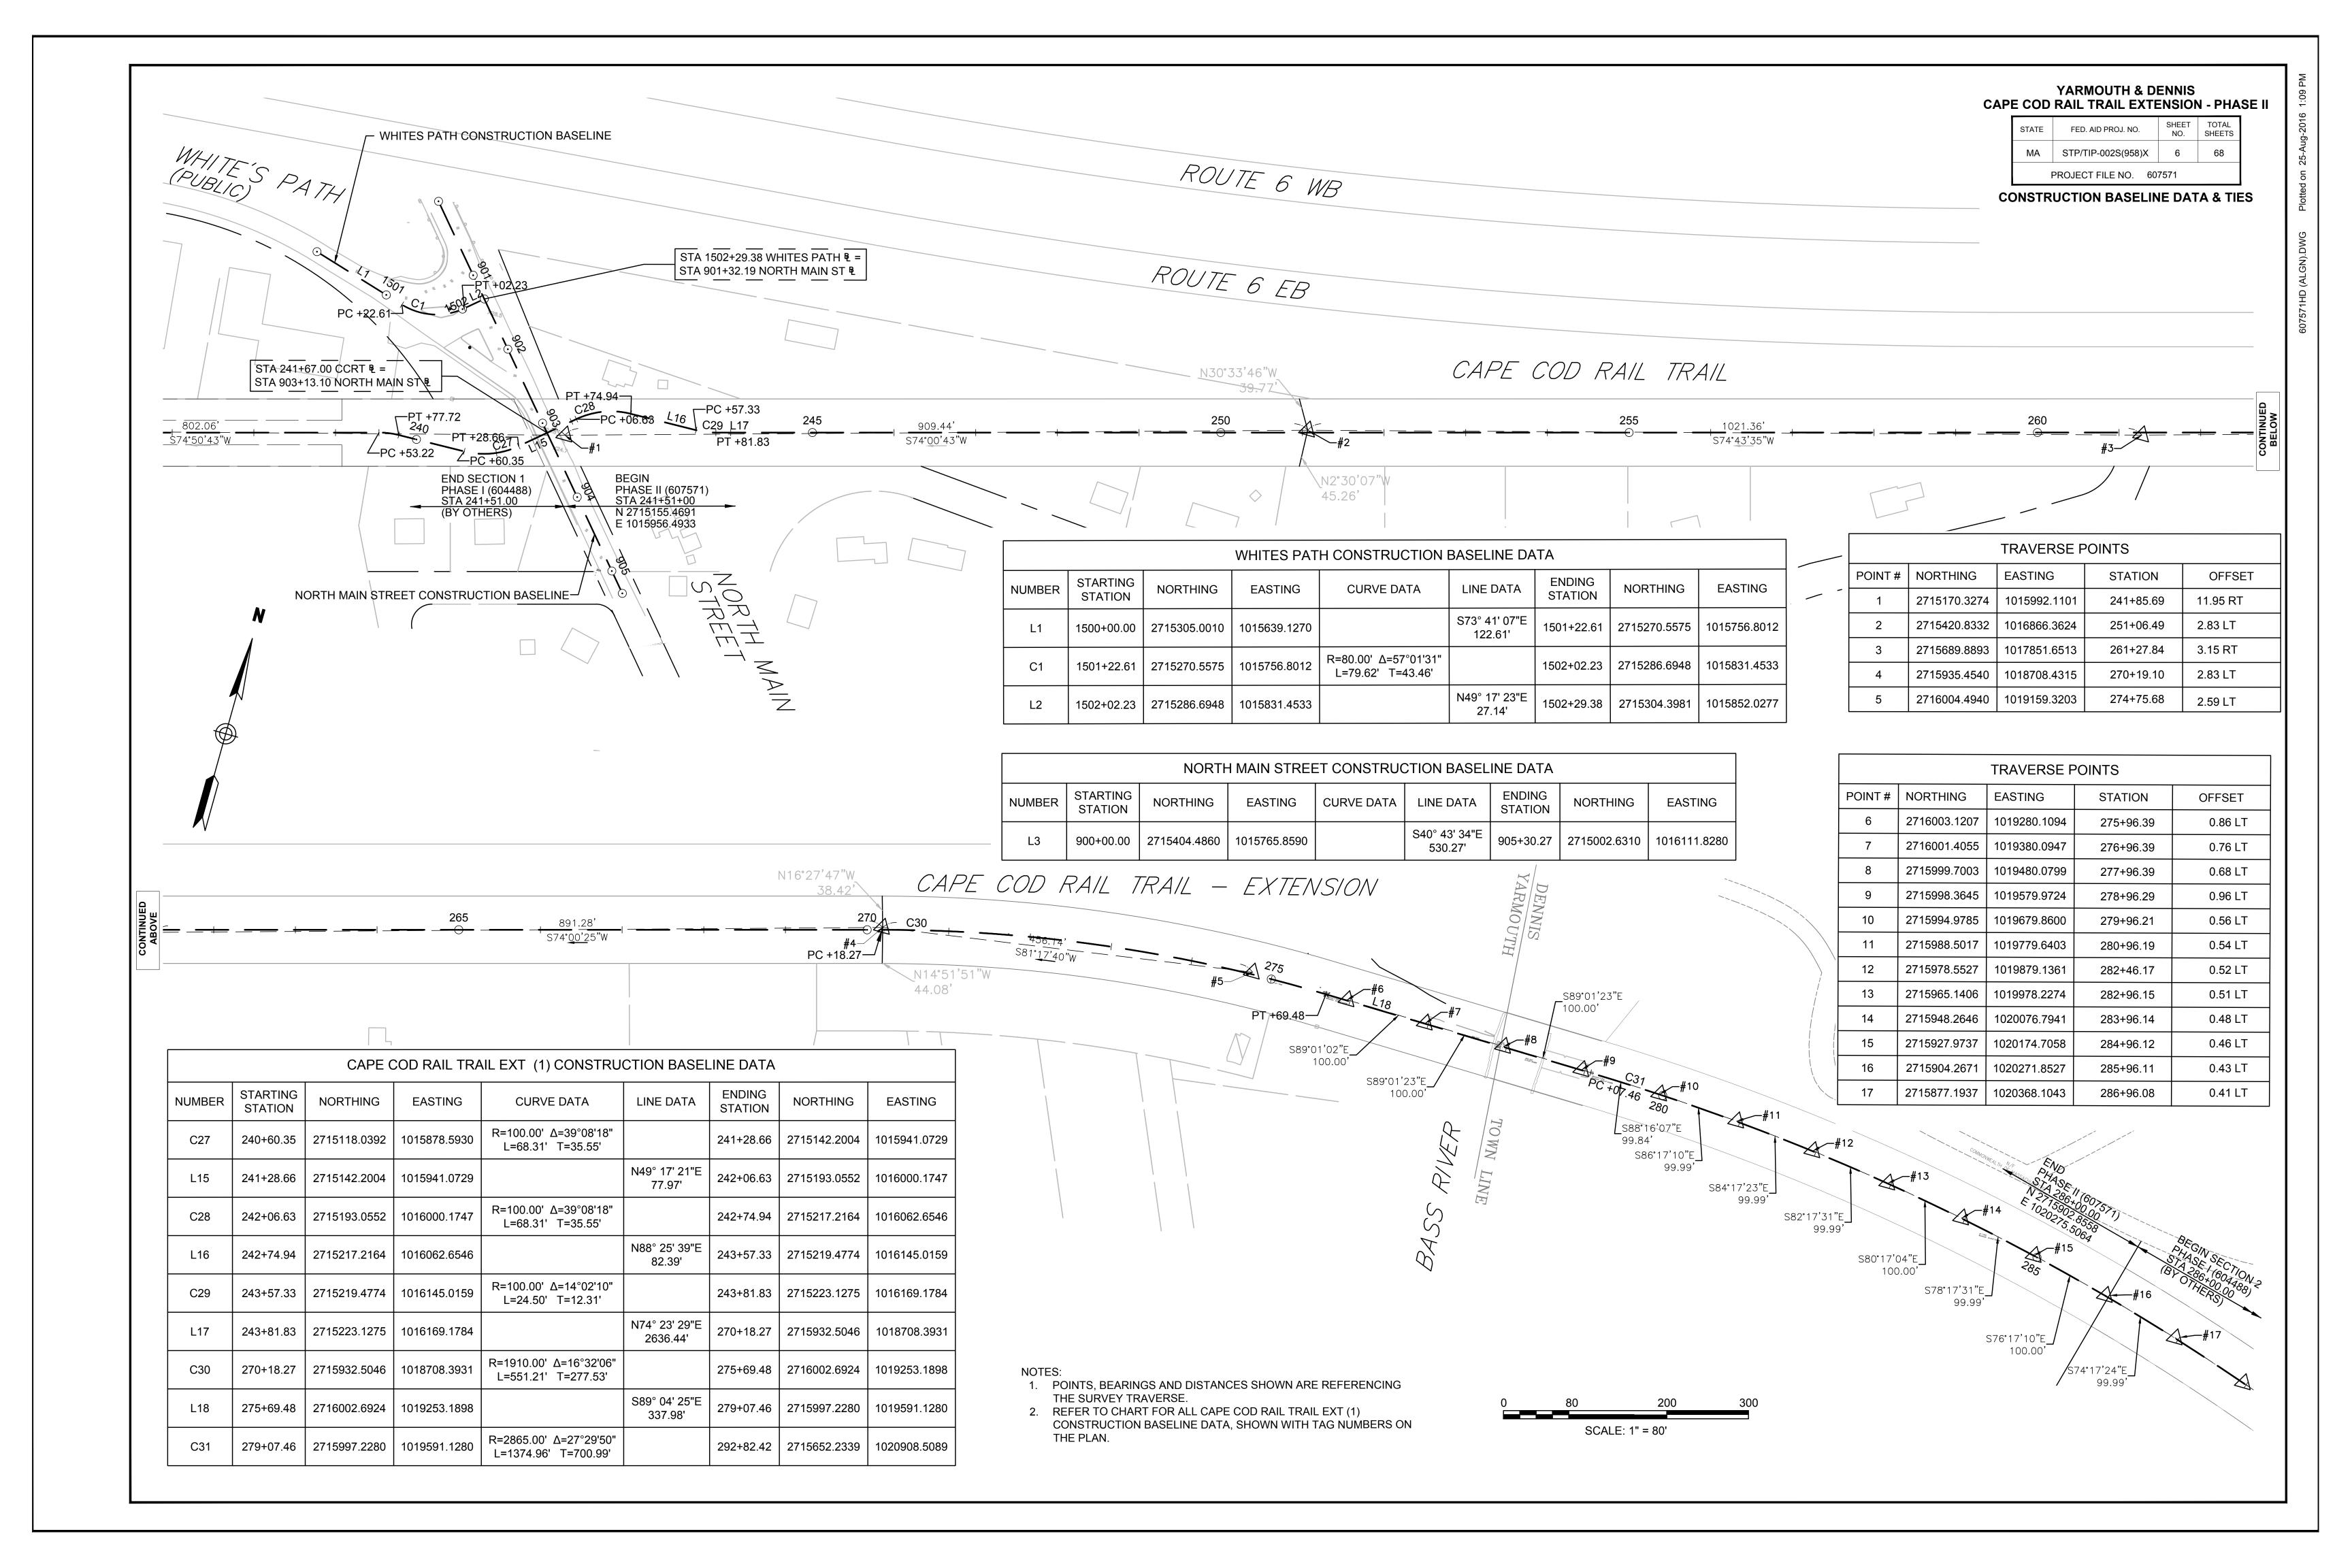


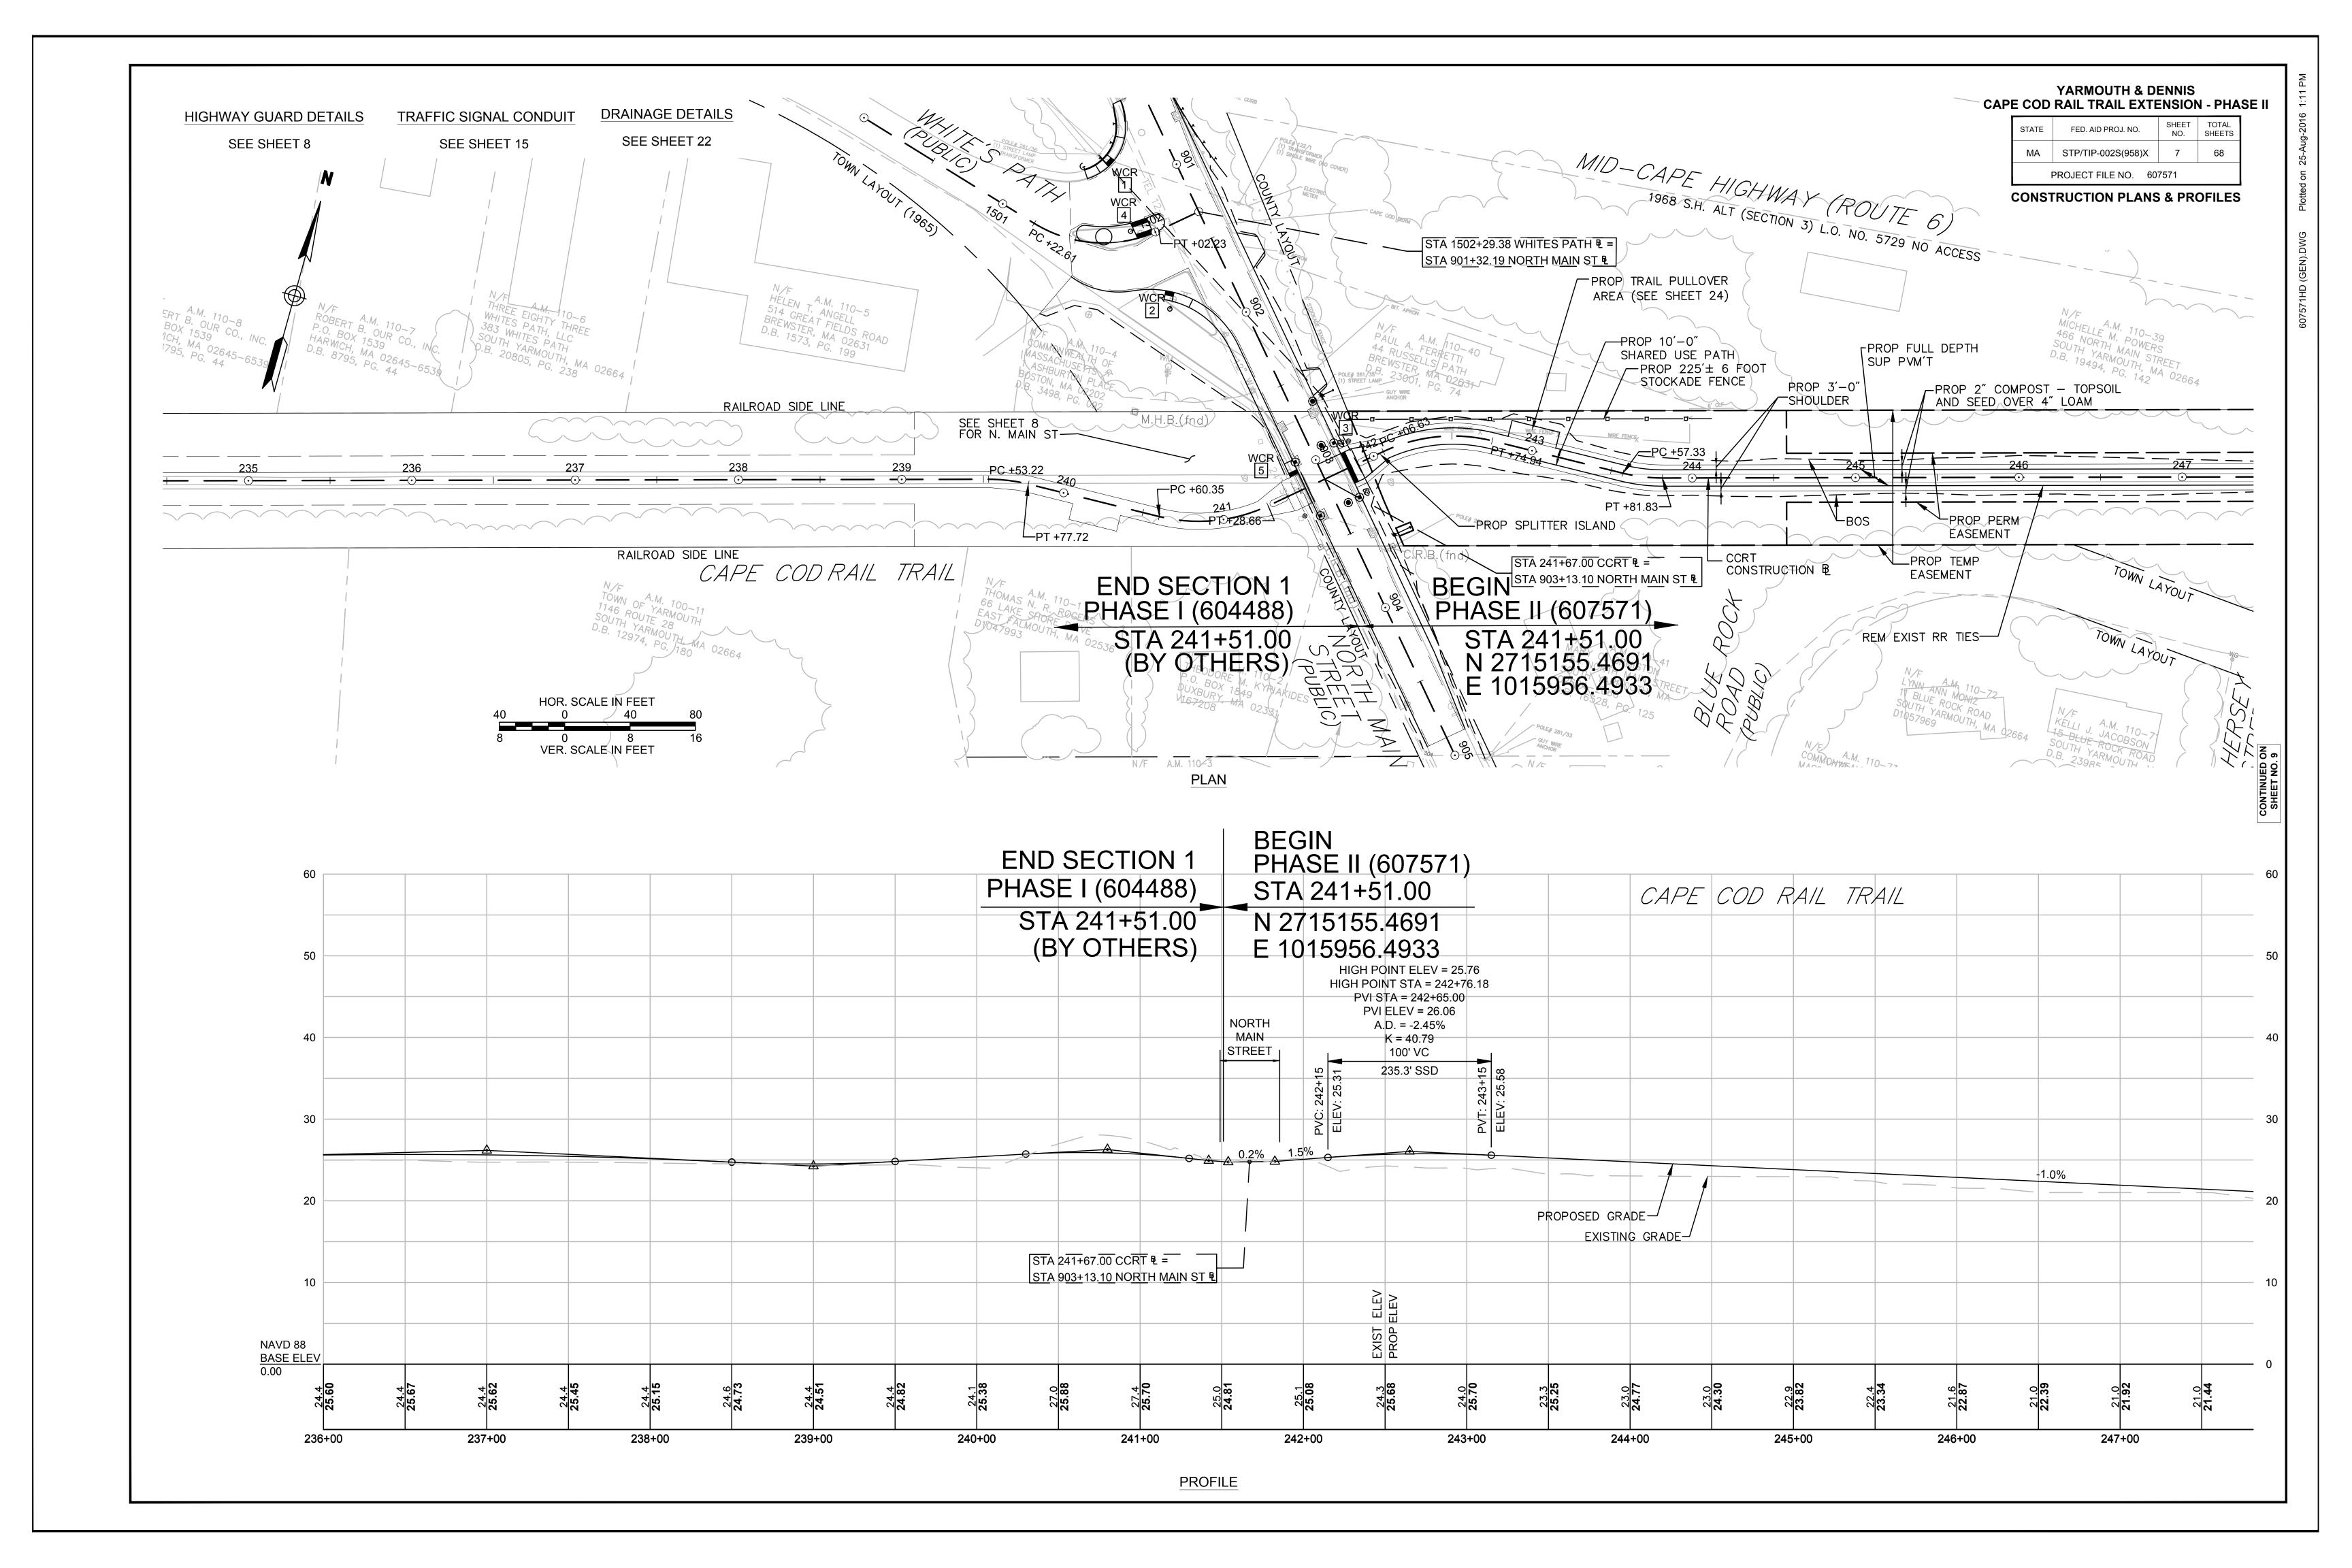


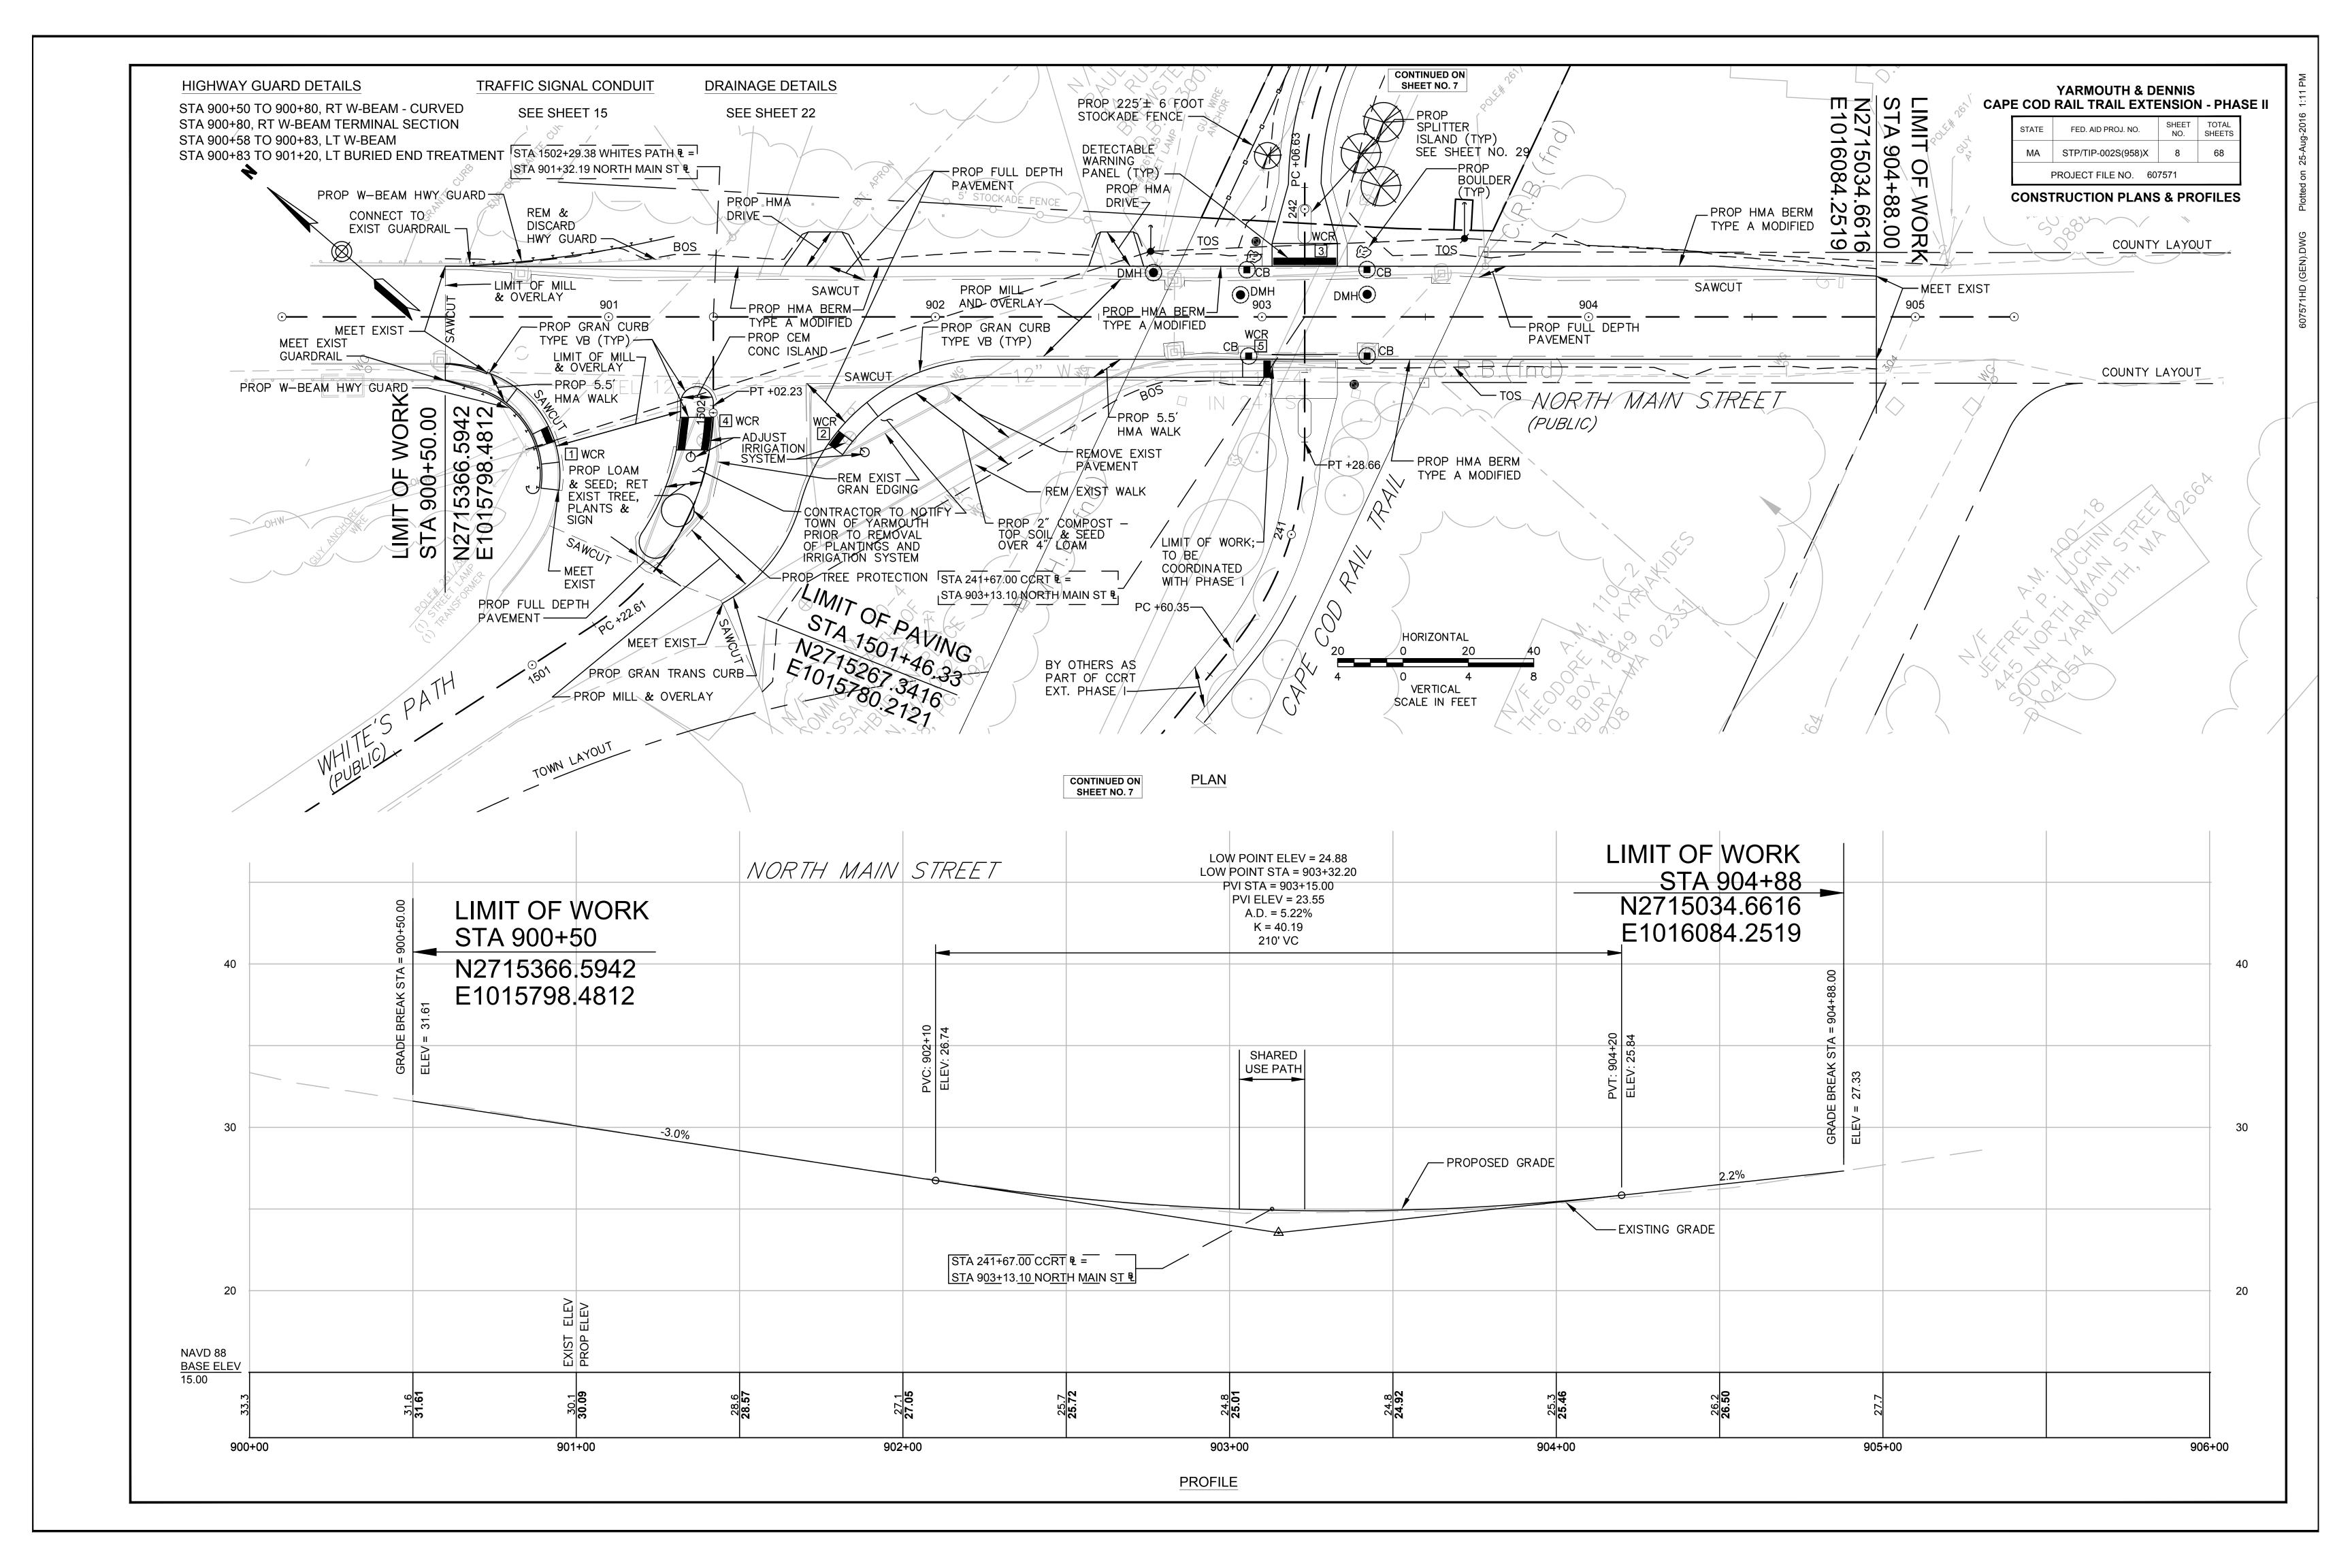

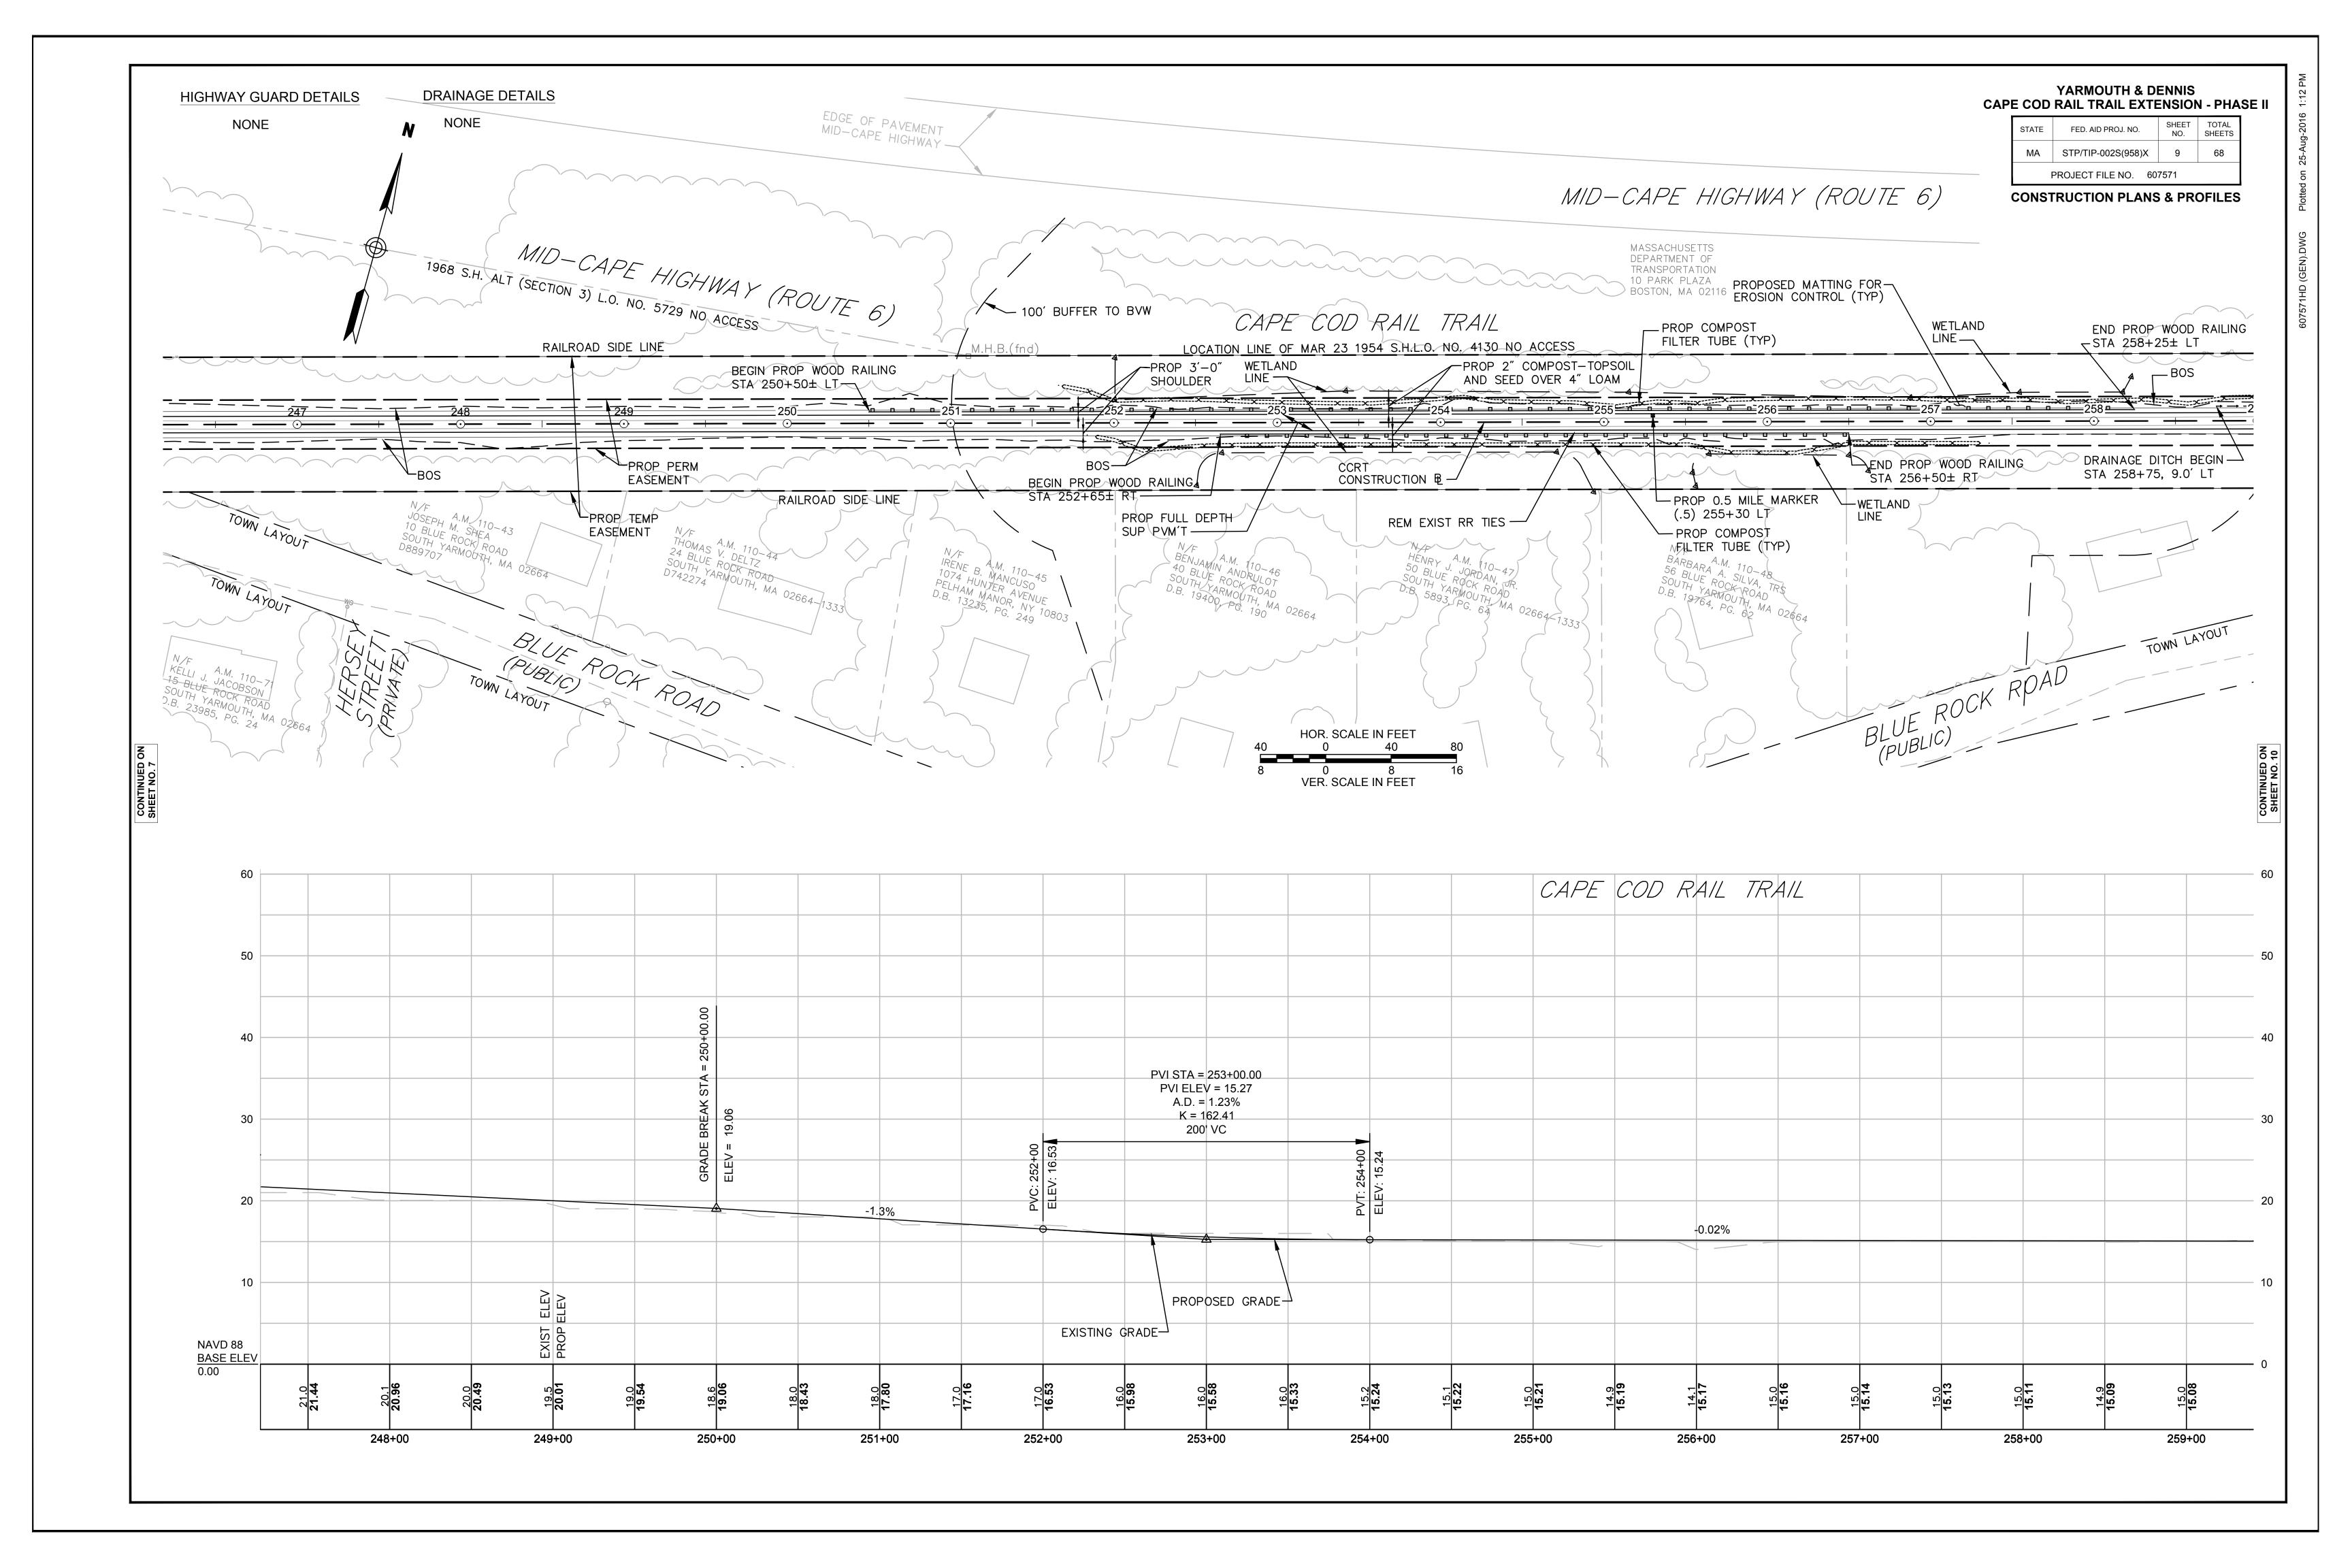


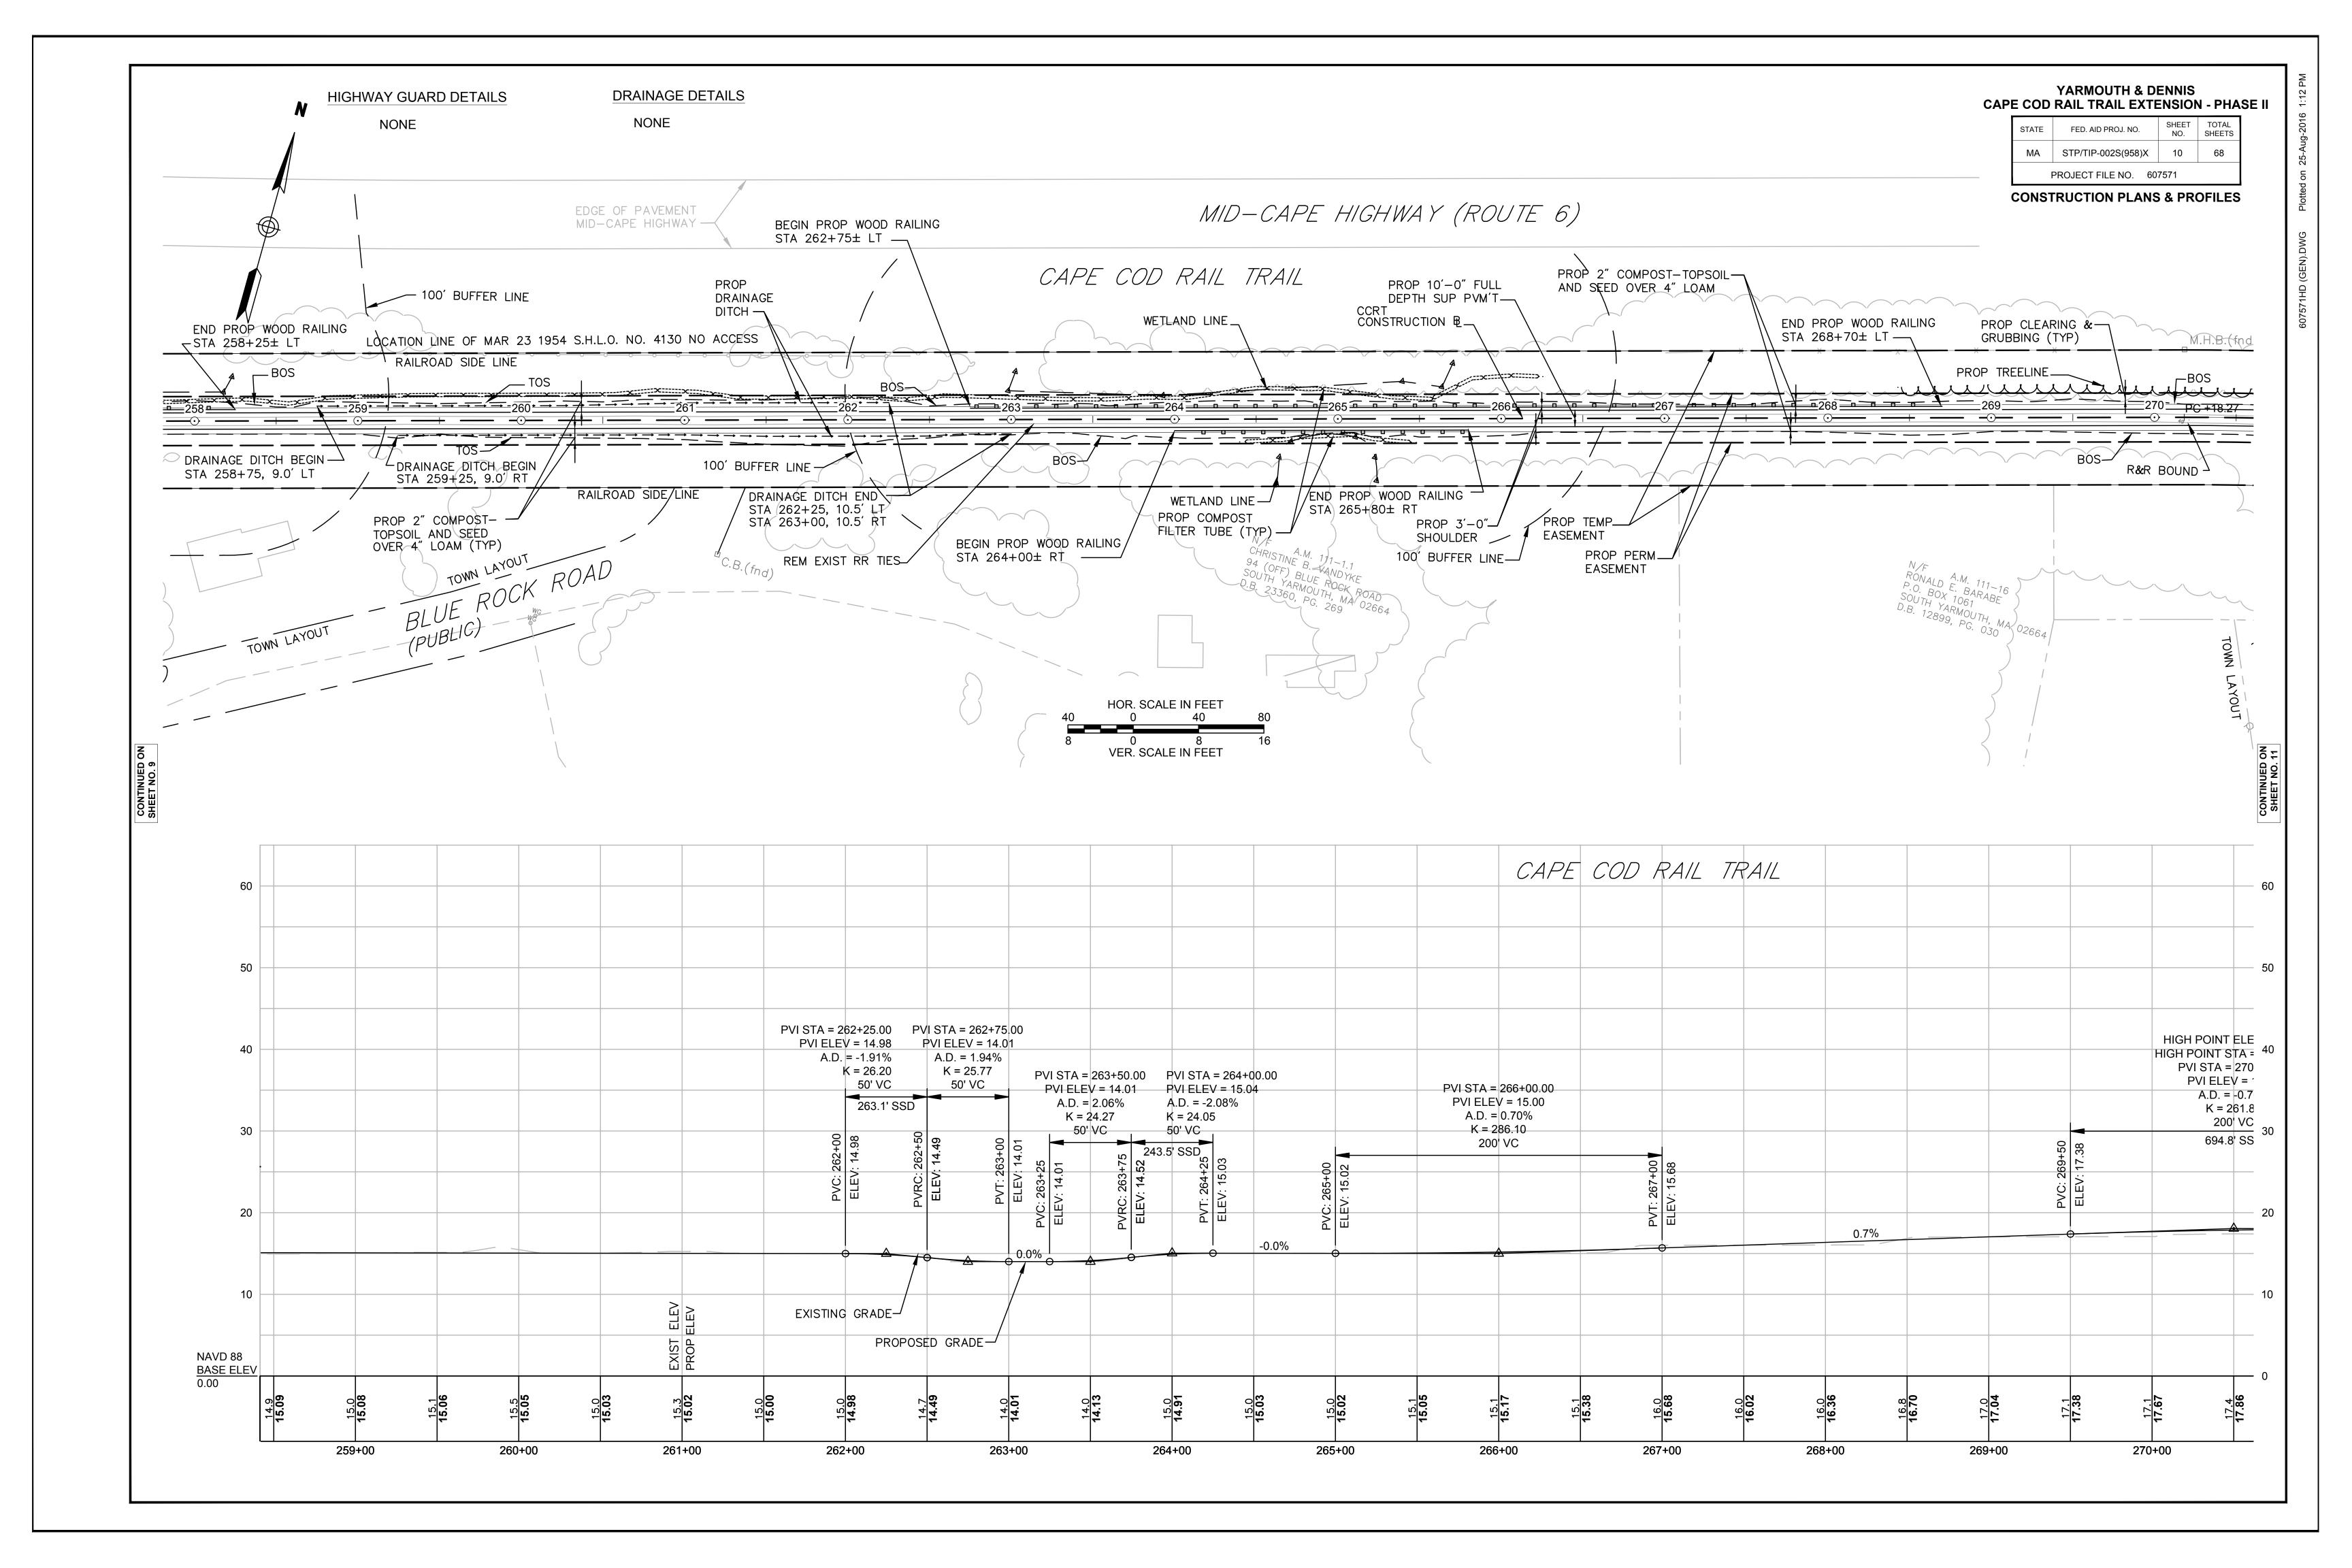


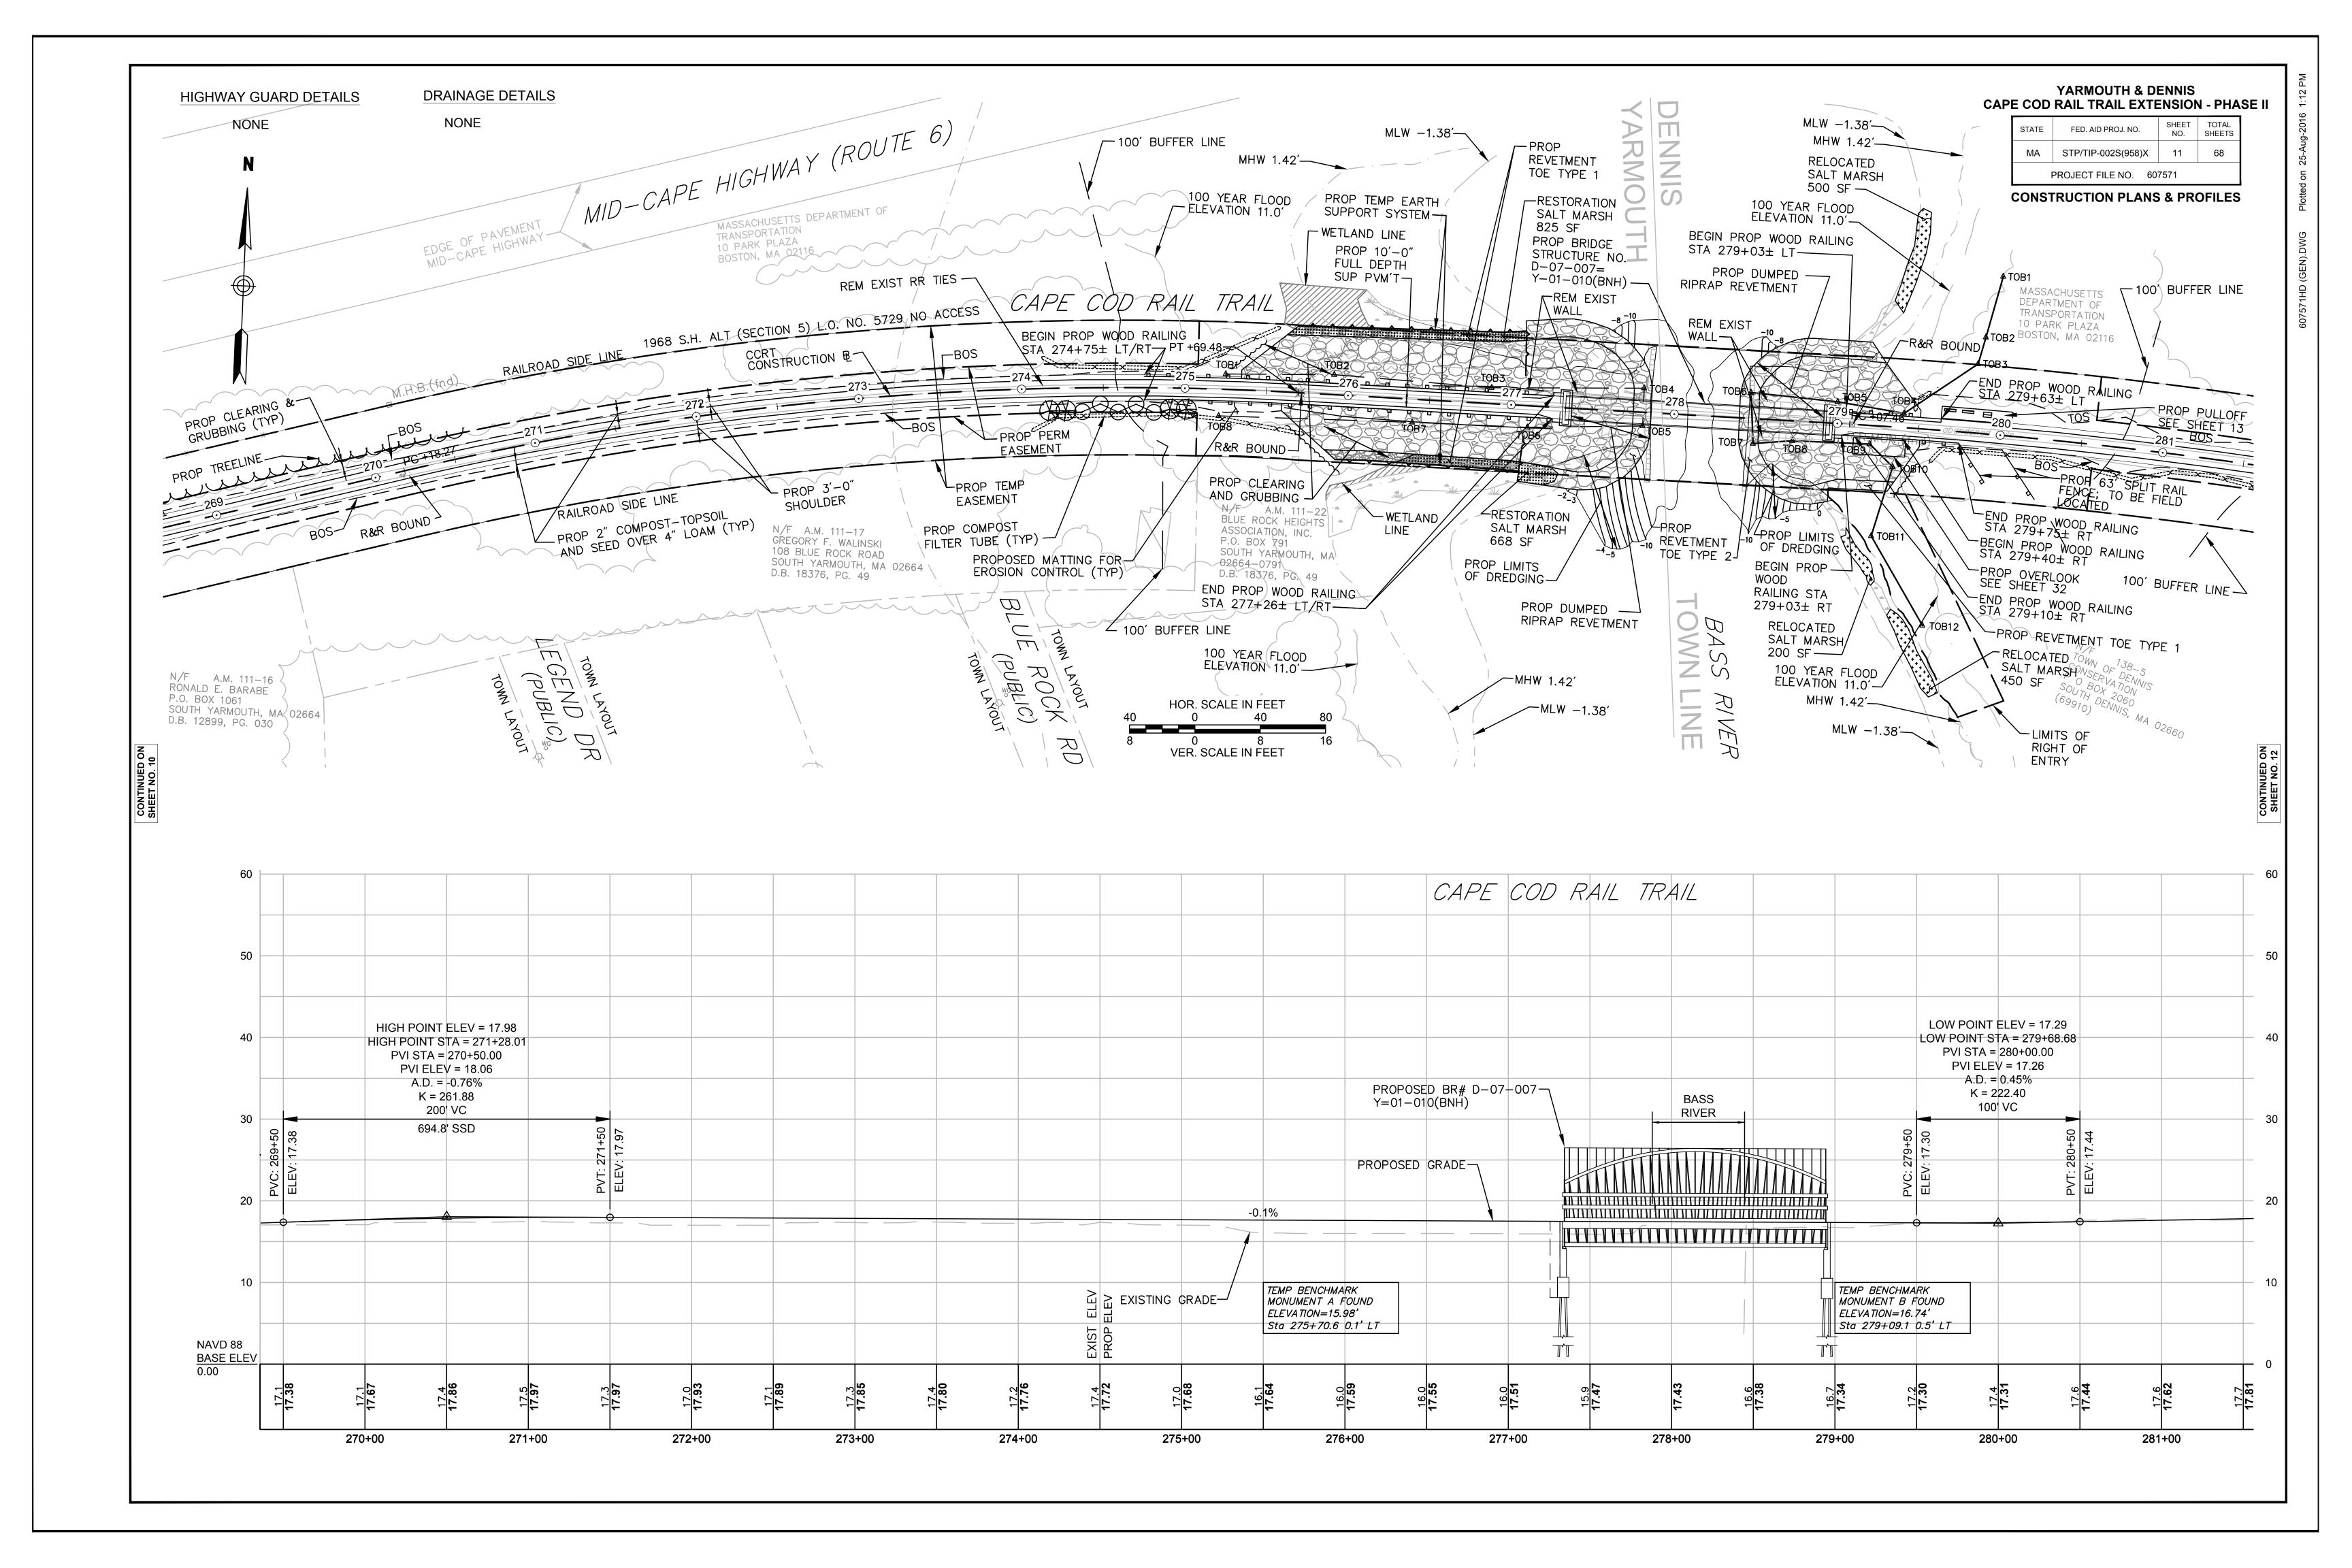

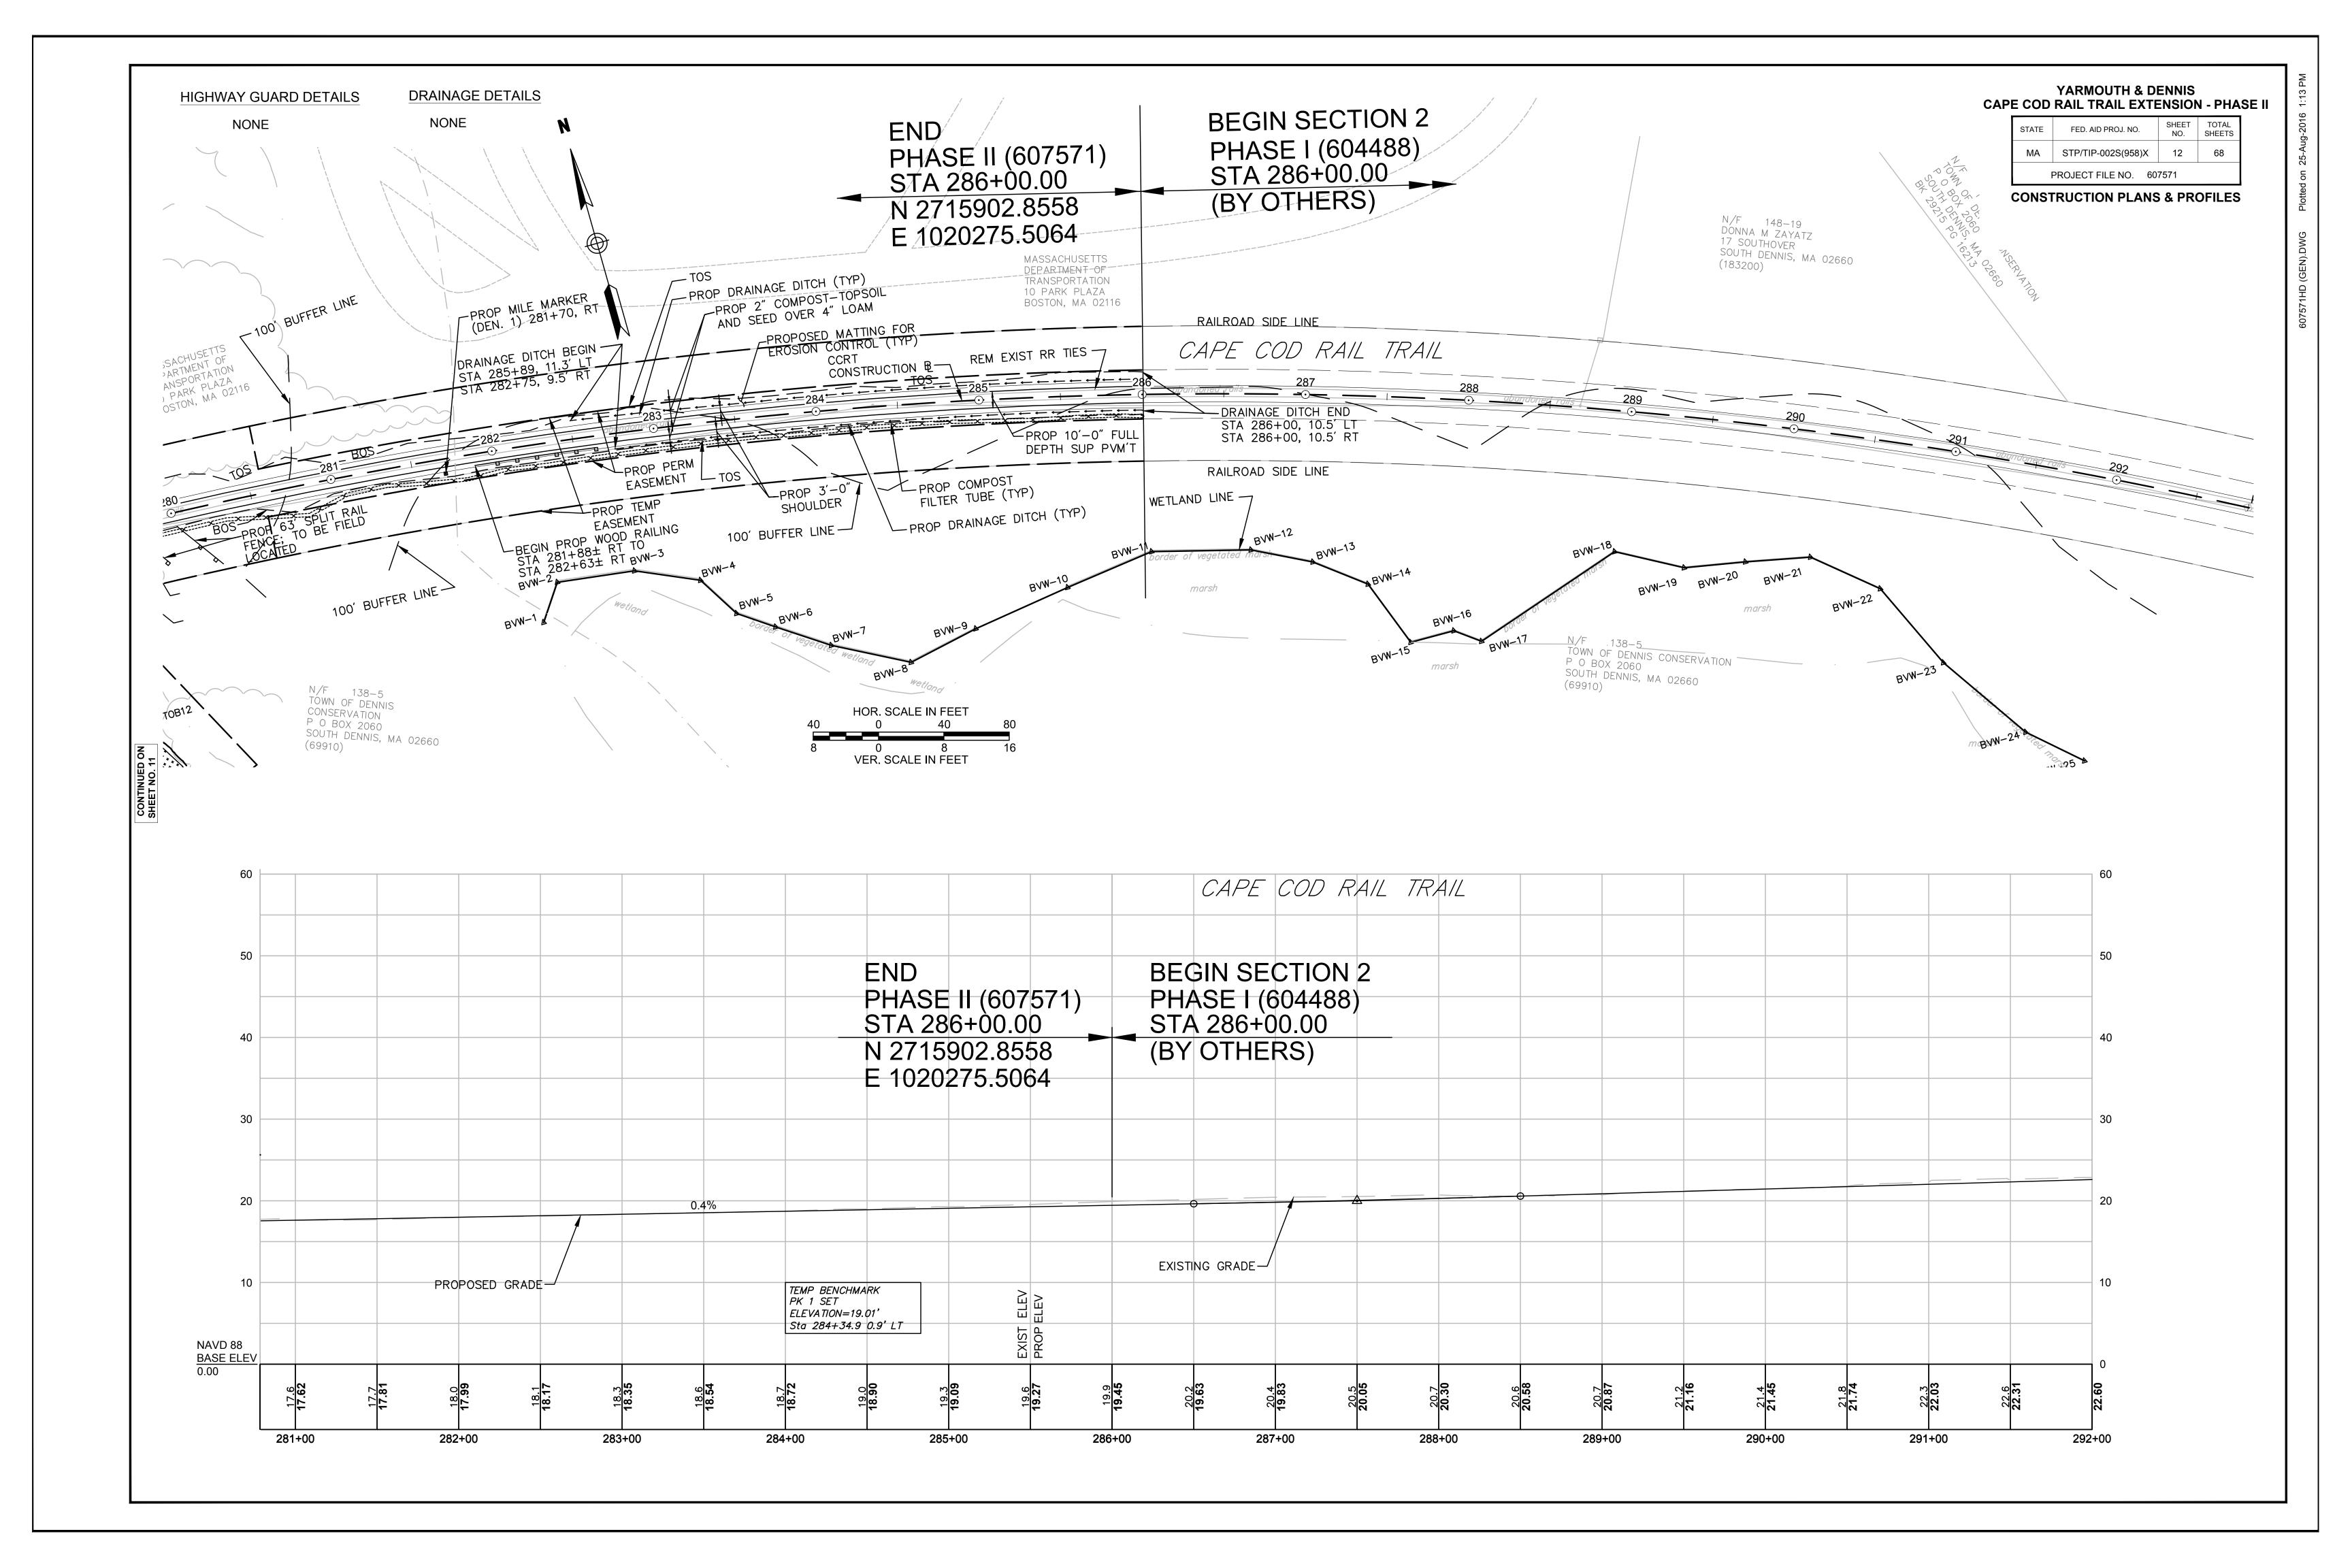

MASTER PLANT	T SUMMARY LIST			YARMOUTH & D CAPE COD RAIL TRAIL EXT
QTY. KEY BOTANICAL NAME EVERGREEN TREES	COMMON NAME UNIT.	SIZE	SPACING	STATE FED. AID PROJ. NO. MA STP/TIP-002S(958)X
4 PS PINUS STROBUS	PINE WHITE EA	5-6' H	10 FT O.C.	PROJECT FILE NO. 60
SHADE TREES 5 HV HAMAMELIS VIRGINIANA WI	WITCH HAZEL SPRING BLOOMING EA	6-7' HTL	12 FT O.C.	CONSTRUCTION PLAN - I BASS RIVER RES
100' BUFFER LINE CAPE COD R 2 PS	COMPOST FILTER TUBE SEE SHEET 26 COMPOST FILTER TUBE 275 COMPOST FILTER TUBE SEE SHEET 26			MIN 1.32 MIN 1.32 MIN 1.33 MIN 1.35 MIN 1.

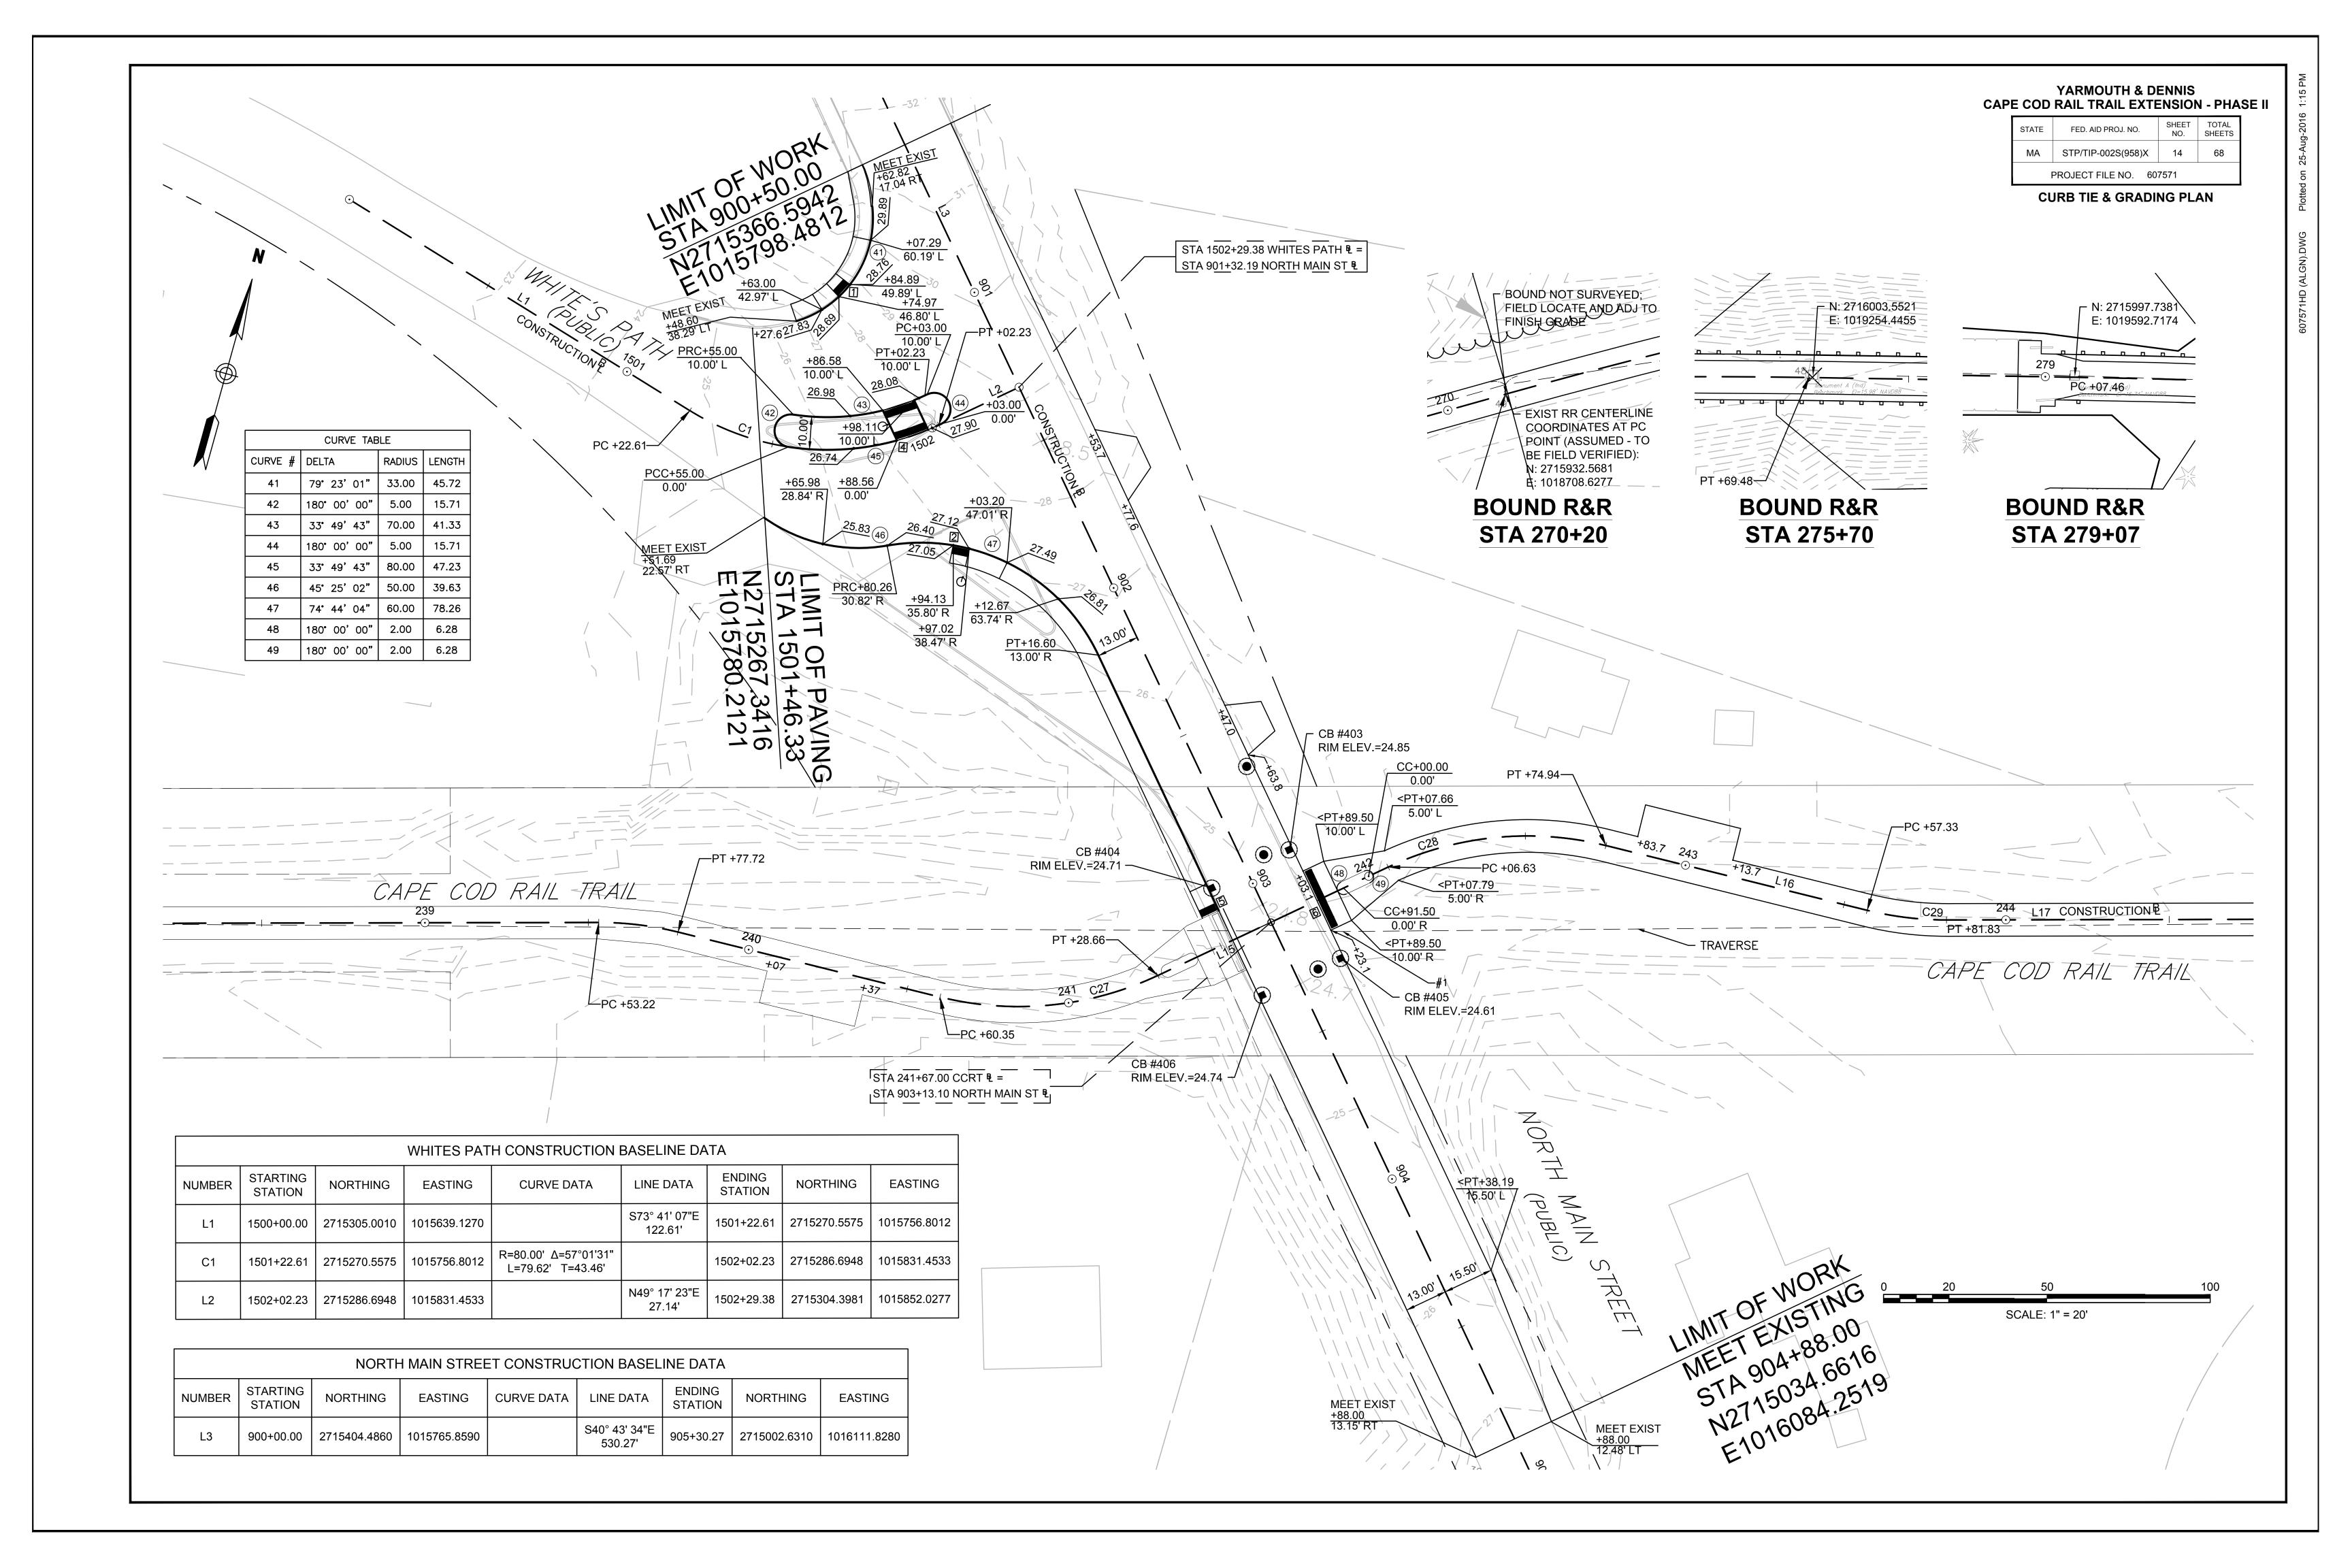

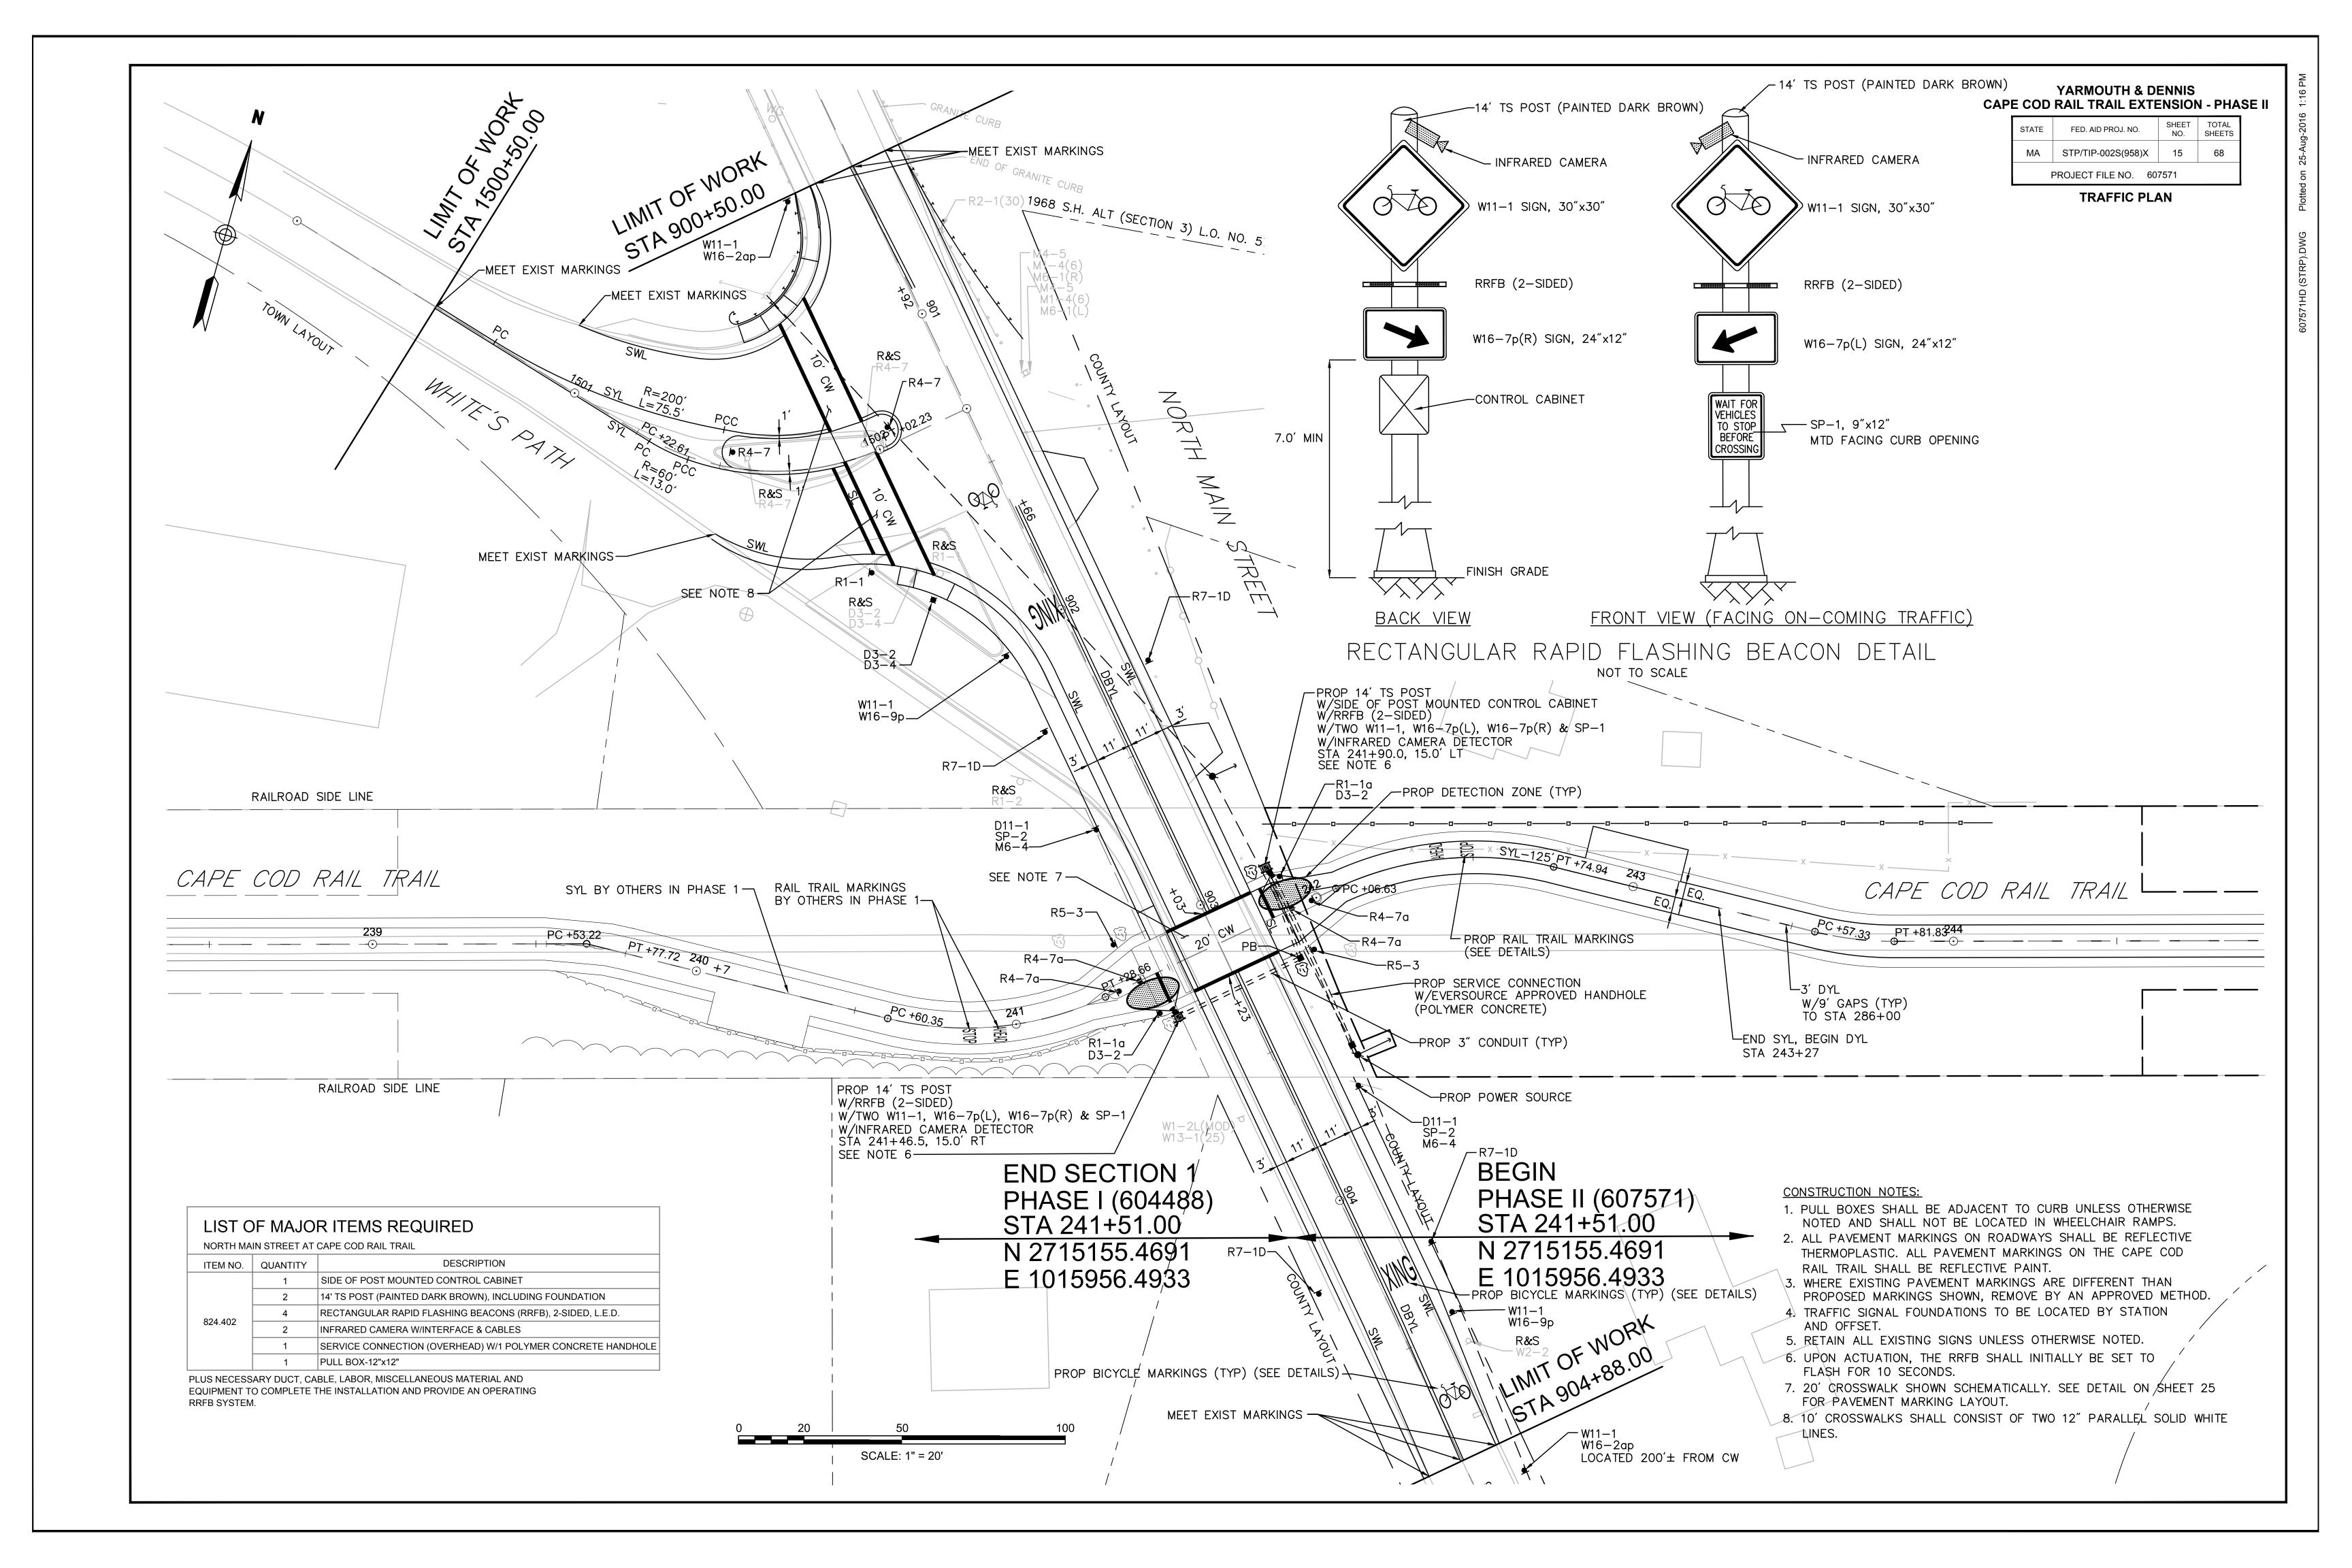

IDENTIFI—	SIZE 0	F SIGN		TEXT DI	MENSIONS	(INCHES)	NUMBER		COLOR		POST SIZE	UNIT	AREA IN
CATION NUMBER	WIDTH	HEIGHT	TEXT	LETTER HEIGHT	VERTICAL SPACING	ARROW RTE. MKR.	OF SIGNS REQUIRED	BACK- GROUND	LEGEND	BORDER	AND NUMBER REQUIRED	AREA (S.F.)	SQUARE FEET
R1-1	30"	30"	STOP	SEE FI HIG	HWA "STANE HWAY SIGN FION"; AS AN	DARD IS,	1	RED	WHITE	WHITE	P5-1	5.18	5.18
R1-1a	18"	18"	STOP				2	RED	WHITE	WHITE	2 MTD W/OTHERS	1.86	3.72
R4-7	24"	30"					2	WHITE	BLACK	BLACK	P5-2	5.00	10.00
R4-7a	18"	24"					4	WHITE	BLACK	BLACK	P5-4	3.00	12.00
R5-3	24"	24"	NO MOTOR VEHICLES				2	WHITE	BLACK	BLACK	P5-2	4.00	8.00
R7-1D	12"	18"	NO PARKING ANYTIME				4	WHITE	RED	RED	P5-4	1.50	6.00
M6-4	21"	15"	+				2	GREEN	WHITE	WHITE	2 MTD W/OTHERS	2.19	4.38
W11-1	30"	30"	(3.70)				8	YELLOW	BLACK	BLACK	P5-4 4 MTD ON TS POST	6.25	50.00
W16-2ap	24"	12"	200 FT				2	YELLOW	BLACK	BLACK	2 MTD W/OTHERS	2.00	4.00
W16-7p(L)	24"	12"					2	YELLOW	BLACK	BLACK	2 MTD ON TS POST	2.00	4.00
W16-7p(R)	24"	12"					2	YELLOW	BLACK	BLACK	2 MTD ON TS POST	2.00	4.00
W16-9p	24"	12"	AHEAD				2	YELLOW	BLACK	BLACK	2 MTD W/OTHERS	2.00	4.00
D11-1	24"	18"	BIKE ROUTE		V		2	GREEN	WHITE	WHITE	P5-2	3.00	6.00
D3-2	48"	12"	North Main St	6/4	3	N/A	3	GREEN	WHITE	WHITE	P5-3	INCLUDE	ED UNDER 1874
D3-4	42"	12"	White's Path	6/4	3	N/A	1	GREEN	WHITE	WHITE	1 MTD W/OTHERS	INCLUDE	ED UNDER 1874
SP-1	9"	12"	WAIT FOR VEHICLES TO STOP BEFORE CROSSING	1"C 1"C 1"C 1"C 1"C	1.5" 1" 1" 1" 1"	N/A	2	YELLOW	BLACK	BLACK	2 MTD ON TS POLE	0.75	1.50
SP-2	18"	12"	CCRT	4"D	4" 4"	N/A	2	GREEN	WHITE	WHITE	2 MTD W/OTHERS	1.50	3.00

NOTE: HIGH INTENSITY REFLECTIVE SHEETING SHALL BE USED FOR ALL SIGNS. SEE 2009 MANUAL ON UNIFORM TRAFFIC CONTROL DEVICES FOR STREETS AND HIGHWAYS, FOR VERTICAL & LATERAL CLEARANCES.

YARMOUTH & DENNIS CAPE COD RAIL TRAIL EXTENSION - PHASE II

STATE	FED. AID PROJ. NO.	SHEET NO.	TOTAL SHEETS				
MA	STP/TIP-002S(958)X	16	68				
PROJECT FILE NO 607571							

- 2. NO WORK SHALL OCCUR WITHIN THE PUBLIC WAY ON TOWN RECOGNIZED HOLIDAYS UNLESS OTHERWISE APPROVED BY THE ENGINEER.
- 3. WORK SHALL NOT AFFECT TRAFFIC PATTERNS DURING PEAK TRAFFIC PERIODS. PEAK TRAFFIC PERIODS ARE DEFINED AS MONDAY THRU FRIDAY 6:00AM-9:00AM AND 3:00PM-6:00PM.
- 4. ALL DRUMS SHALL BE SET AT 20' ON CENTER MAX. ON LOCAL ROADWAY. UNLESS OTHERWISE NOTED OR ADJUSTED BY THE ENGINEER.
- 5. ALL DRUMS SHALL BE APPROXIMATELY PLACED AND MOVED AS NECESSARY TO MAINTAIN ADEQUATE ABUTTER ACCESS AT ALL TIMES. WORK MAY REQUIRE ADDITIONAL SIGNS, DRUMS AND OTHER TRAFFIC CONTROL DEVICES, GRADING AND TEMPORARY PAVEMENT FOR PASSAGE OF PEDESTRIAN, VEHICULAR AND EMERGENCY TRAFFIC THROUGH THE WORK AREAS, BOTH DURING AND AFTER WORKING HOURS, TO MAINTAIN SUCH ACCESS.
- 6. THE CONTRACTOR SHALL NOTIFY EACH ABUTTOR AT LEAST 24 HOURS IN ADVANCE OF THE START OF ANY WORK THAT WILL REQUIRE THE TEMPORARY CLOSURE OF ACCESS.
- 7. FOR RESTORATIVE WORK ON LOCAL ROADWAYS, A MINIMUM OF ONE LANE OF TRAFFIC IN EACH DIRECTION ON TWO WAY STREETS SHALL BE MAINTAINED AT ALL TIMES, EXCEPT THAT DURING WORKING HOURS, TRAFFIC MAY BE REDUCED TO ONE LANE UNDER POLICE CONTROL FOR SHORT TIME PERIODS WHEN REQUIRED FOR THE WORK, AS SHOWN UNLESS OTHERWISE APPROVED BY THE ENGINEER.
- 8. FOR DROP-OFFS 4" OR LESS, CONDITION MAY BE MITIGATED WITH W8-9 (LOW SHOULDER) SIGN OR TEMPORARY CHANNELIZATION DEVICES. FOR DROP-OFFS GREATER THAN 4" BUT NO MORE THAN 12", DETERMINE WHETHER IT IS MORE COST EFFECTIVE TO INSTALL BOTH TEMPORARY CHANNELIZATION DEVICES AND A 1V:4H (MIN) TO 1V:6H (DESIRED) WEDGE OR TO SHIELD IT. FOR DROP-OFFS GREATER THAN 12" BUT NO MORE THAN 24", DETERMINE WHETHER IT IS MORE COST EFFECTIVE TO MAINTAIN AN ADDITIONAL 5' OF SHOULDER WIDTH AND INSTALL BOTH TEMPORARY CHANNELIZATION DEVICES AND A 1V:6H (DESIRE) WEDGE OR TO SHIELD IT. FOR DROP-OFFS 24" OR GREATER USE BARRIER IN ACCORDANCE WITH MASSDOT WORK ZONE POSITIVE PROTECTION GUIDELINES.
- 9. 11' MINIMUM LANE WIDTHS SHALL BE MAINTAINED.
- 10. NON-ESSENTIAL TRAFFIC CONTROL DEVICES AND SIGNS SHALL BE COVERED OR REMOVED DURING NON-WORKING HOURS WHEN NOT IN USE.
- 11. ADVISORY SPEED PLATES (W13-1P) SHALL BE USED AS SHOWN AND AS REQUESTED BY THE ENGINEER.
 POSTED ADVISORY SPEED SHALL BE AS APPROVED BY THE APPROPRIATE AGENCY WITH JURISDICTION OVER
 THE ROADWAY ON WHICH THE SIGN WILL BE MOUNTED.
- 12. SIGNS INSTALLED ON PORTABLE STANDS REQUIRE 12 INCH MINIMUM MOUNTING HEIGHT FROM THE ROADWAY SURFACE TO THE BOTTOM OF THE SIGN.
- 13. SIGNS INSTALLED ON PORTABLE STANDS PLACED AMONG CHANNELIZATION DEVICES REQUIRE A 36 INCH MINIMUM MOUNTING HEIGHT FROM THE ROADWAY SURFACE TO THE BOTTOM OF THE SIGN.
- 14. SIGNS MOUNTED ON P5 POSTS REQUIRE A MINIMUM 84 INCH MOUNTING HEIGHT FROM THE ROADWAY OR SIDEWALK SURFACE TO THE BOTTOM OF THE SIGN.
- 15. W20-7b SIGNS SHALL BE REPLACED BY W20-7 SIGNS WHEN FLAGGERS ARE USED IN LIEU OF POLICE OFFICER DETAILS.
- 16. REFLECTORIZED CONES SHALL BE A MINIMUM OF 36 INCHES IN HEIGHT.
- 17. CONES MAY BE USED IN LIEU OF DRUMS OUTSIDE OF TAPER AREAS.
- 18. THERE IS NO DESIGNATED BICYCLE LANE ON THE ROADWAY WITHIN THE PROJECT LIMITS. BICYCLES ARE EXPECTED TO SHARE THE ROAD WITH GENERAL VEHICULAR TRAFFIC.
- 19. CONTRACTOR SHALL SECURE WORK AREAS TO PREVENT UNAUTHORIZED ACCESS AT ALL TIMES.
- 20. W20-8a SIGNS SHALL BE INSTALLED IN ADVANCE (100' MIN) OF PROPS WHERE UTILITY CASTINGS HAVE BEEN RAISED IN ADVANCE OF PAVING OPERATIONS OR AS REQUESTED BY THE ENGINEER.
- 21. W8-15 SIGNS SHALL BE INSTALLED IN ADVANCE (100' MIN) OF PAVEMENT MILLING PROPS OR AS REQUESTED BY THE ENGINEER.
- 22. TEMPORARY MARKINGS SHALL BE WATERBORNE PAINT ON SURFACE-APPLIED REMOVABLE TAPE AS APPROVED BY THE ENGINEER.
- 23. ALL TEMPORARY CROSSWALKS AND STOP LINES SHALL BE 12 INCHES WIDE.
- 24. ALL TEMPORARY DOUBLE YELLOW LINES (DBYL) SHALL BE 6 INCHES WIDE.
- 25. THE FIRST 5 DRUMS ON TAPERS SHALL BE REFLECTORIZED DRUMS WITH TYPE A LIGHTS.
- 26. W20-8a SIGNS SHALL BE INSTALLED IN ADVANCE (100' MIN) OF AREAS WHERE UTILITY CASTINGS HAVE BEEN RAISED IN ADVANCE OF PAVING OPERATIONS OR AS REQUESTED BY THE ENGINEER.
- 27. W20-1c OR R2-10a SIGNS SHOWN ON ADVANCE SIGN SCHEMATIC MAY BE USED IN LIEU OF THOSE SIGNS SHOWN ON TYPICAL DETAILS ON THE TEMPORARY TRAFFIC CONTROL PLANS IF MINIMUM SIGN SPACING IS MET.
- 28. WHEN UTILIZING TYPICAL TRAFFIC CONTROL DETAILS OR STAGING SETUPS, COVER EXISTING CONFLICTING ADVANCE WARNING SIGNS AS REQUIRED TO COMPLETE THE WORK.
- 29. CONTRACTOR SHALL NOT INSTALL CROSSWALK MARKINGS ON NORTH MAIN STREET OR WHITE'S PATH UNTIL SUCH TIME AS PHASE 2 CAPE COD RAIL TRAIL CONNECTION IS OPEN FOR USE. CONTRACTOR SHALL RETAIN TYPE 3 BARRICADES AND R9 SERIES SIGNS UNTIL FINAL CROSSWALK MARKINGS ARE INSTALLED.

LEGEN	ND
F	FLAGGER
P	POLICE OFFICER
•	REFLECTORIZED DRUM
•	REFLECTORIZED DRUM WITH TYPE A FLASHER
•	TEMPORARY CONSTRUCTION SIGN
•	TRAFFIC CONE
-	TYPE III BARRICADE
	PORTABLE CHANGEABLE MESSAGE SIGN (PCMS)
	WORK AREA (PUBLIC ACCESS RESTRICTED)
←	TRAFFIC FLOW
	PEDESTRIAN ROUTE
	CONSTRUCTION FENCE
CALALA A.	PEDESTRIAN CHANNELIZATION DEVICE
NTS	NOT TO SCALE

ADVANCE SIGN SPACING						
	DISTAN	ICE BETWE	EN SIGNS	(FEET)		
ROAD	А	В	С	D		
N MAIN STREET & WHITES PATH	350	200	350	350		

LAI	NE TAPER LENGTH FORMULA
L=	TAPER LENGTH IN FEET
W=	WIDTH OF ROADWAY TO BE SHIFTED OR REDIRECTED IN FEET
S=	POSTED SPEED LIMIT IN MPH
РО	STED SPEED 40 MPH OR LESS
	$L = \frac{WS^2}{60}$

BUFFER SPACING							
SPEED (MPH)	DISTANCE (FEET)						
20	115						
25	155						
30	200						
35	250						

YARMOUTH & DENNIS
CAPE COD RAIL TRAIL EXTENSION - PHASE I


 STATE
 FED. AID PROJ. NO.
 SHEET NO.
 TOTAL SHEETS

 MA
 STP/TIP-002S(958)X
 17
 68

 PROJECT FILE NO.
 607571

TEMPORARY TRAFFIC CONTROL PLANS
GENERAL NOTES & LEGEND

LANE CLOSURES SHOWN ARE FOR TEMPORARY CONSTRUCTION.
ALL DRUMS AND SIGNS ARE SHOWN AS THEY SHOULD APPEAR
DURING THE WORKING DAY, OR WHILE OPERATING IN THE WORK ZONE.

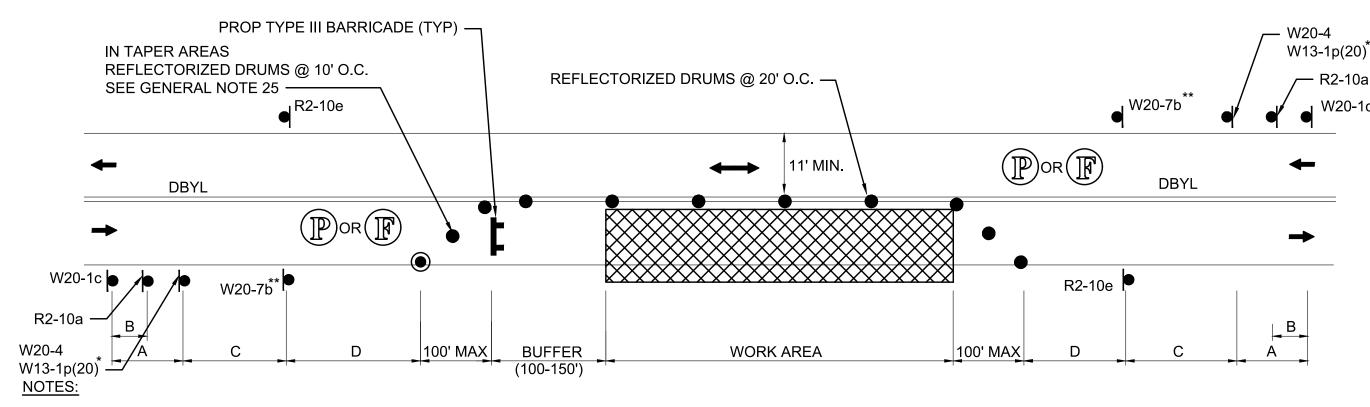


1. SEE BUFFER SPACING CHART AT LEFT.

2. REFER TO ADVANCE SIGN SPACING TABLE AT LEFT.

3. * SEE TTCP GENERAL NOTE 11.4. ** SEE TTCP GENERAL NOTE 15.

TYPICAL TWO-WAY STREET LANE CLOSURE ALTERNATING TRAFFIC

SCALE: NTS

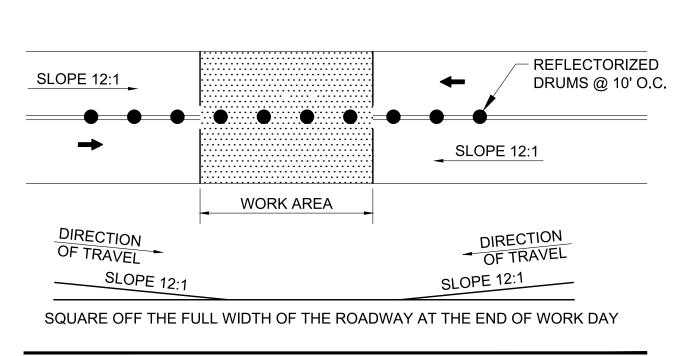

TEMPORARY PAVEMENT TRANSITION DETAIL

SCALE: NTS


WORK AREA 2' TRAVEL WAY

1V:4H (MIN)
1V:6H (DESIRED)
1V:6H (DE

NOTE:
CONTRACTOR SHALL INSTALL W8-9 SIGN ON ALL ROADWAYS 350 FT IN ADVANCE OF THE START OF DROP-OFF CONDITION.


TYPICAL ROADWAY DROP-OFF PROTECTION

SCALE: NTS

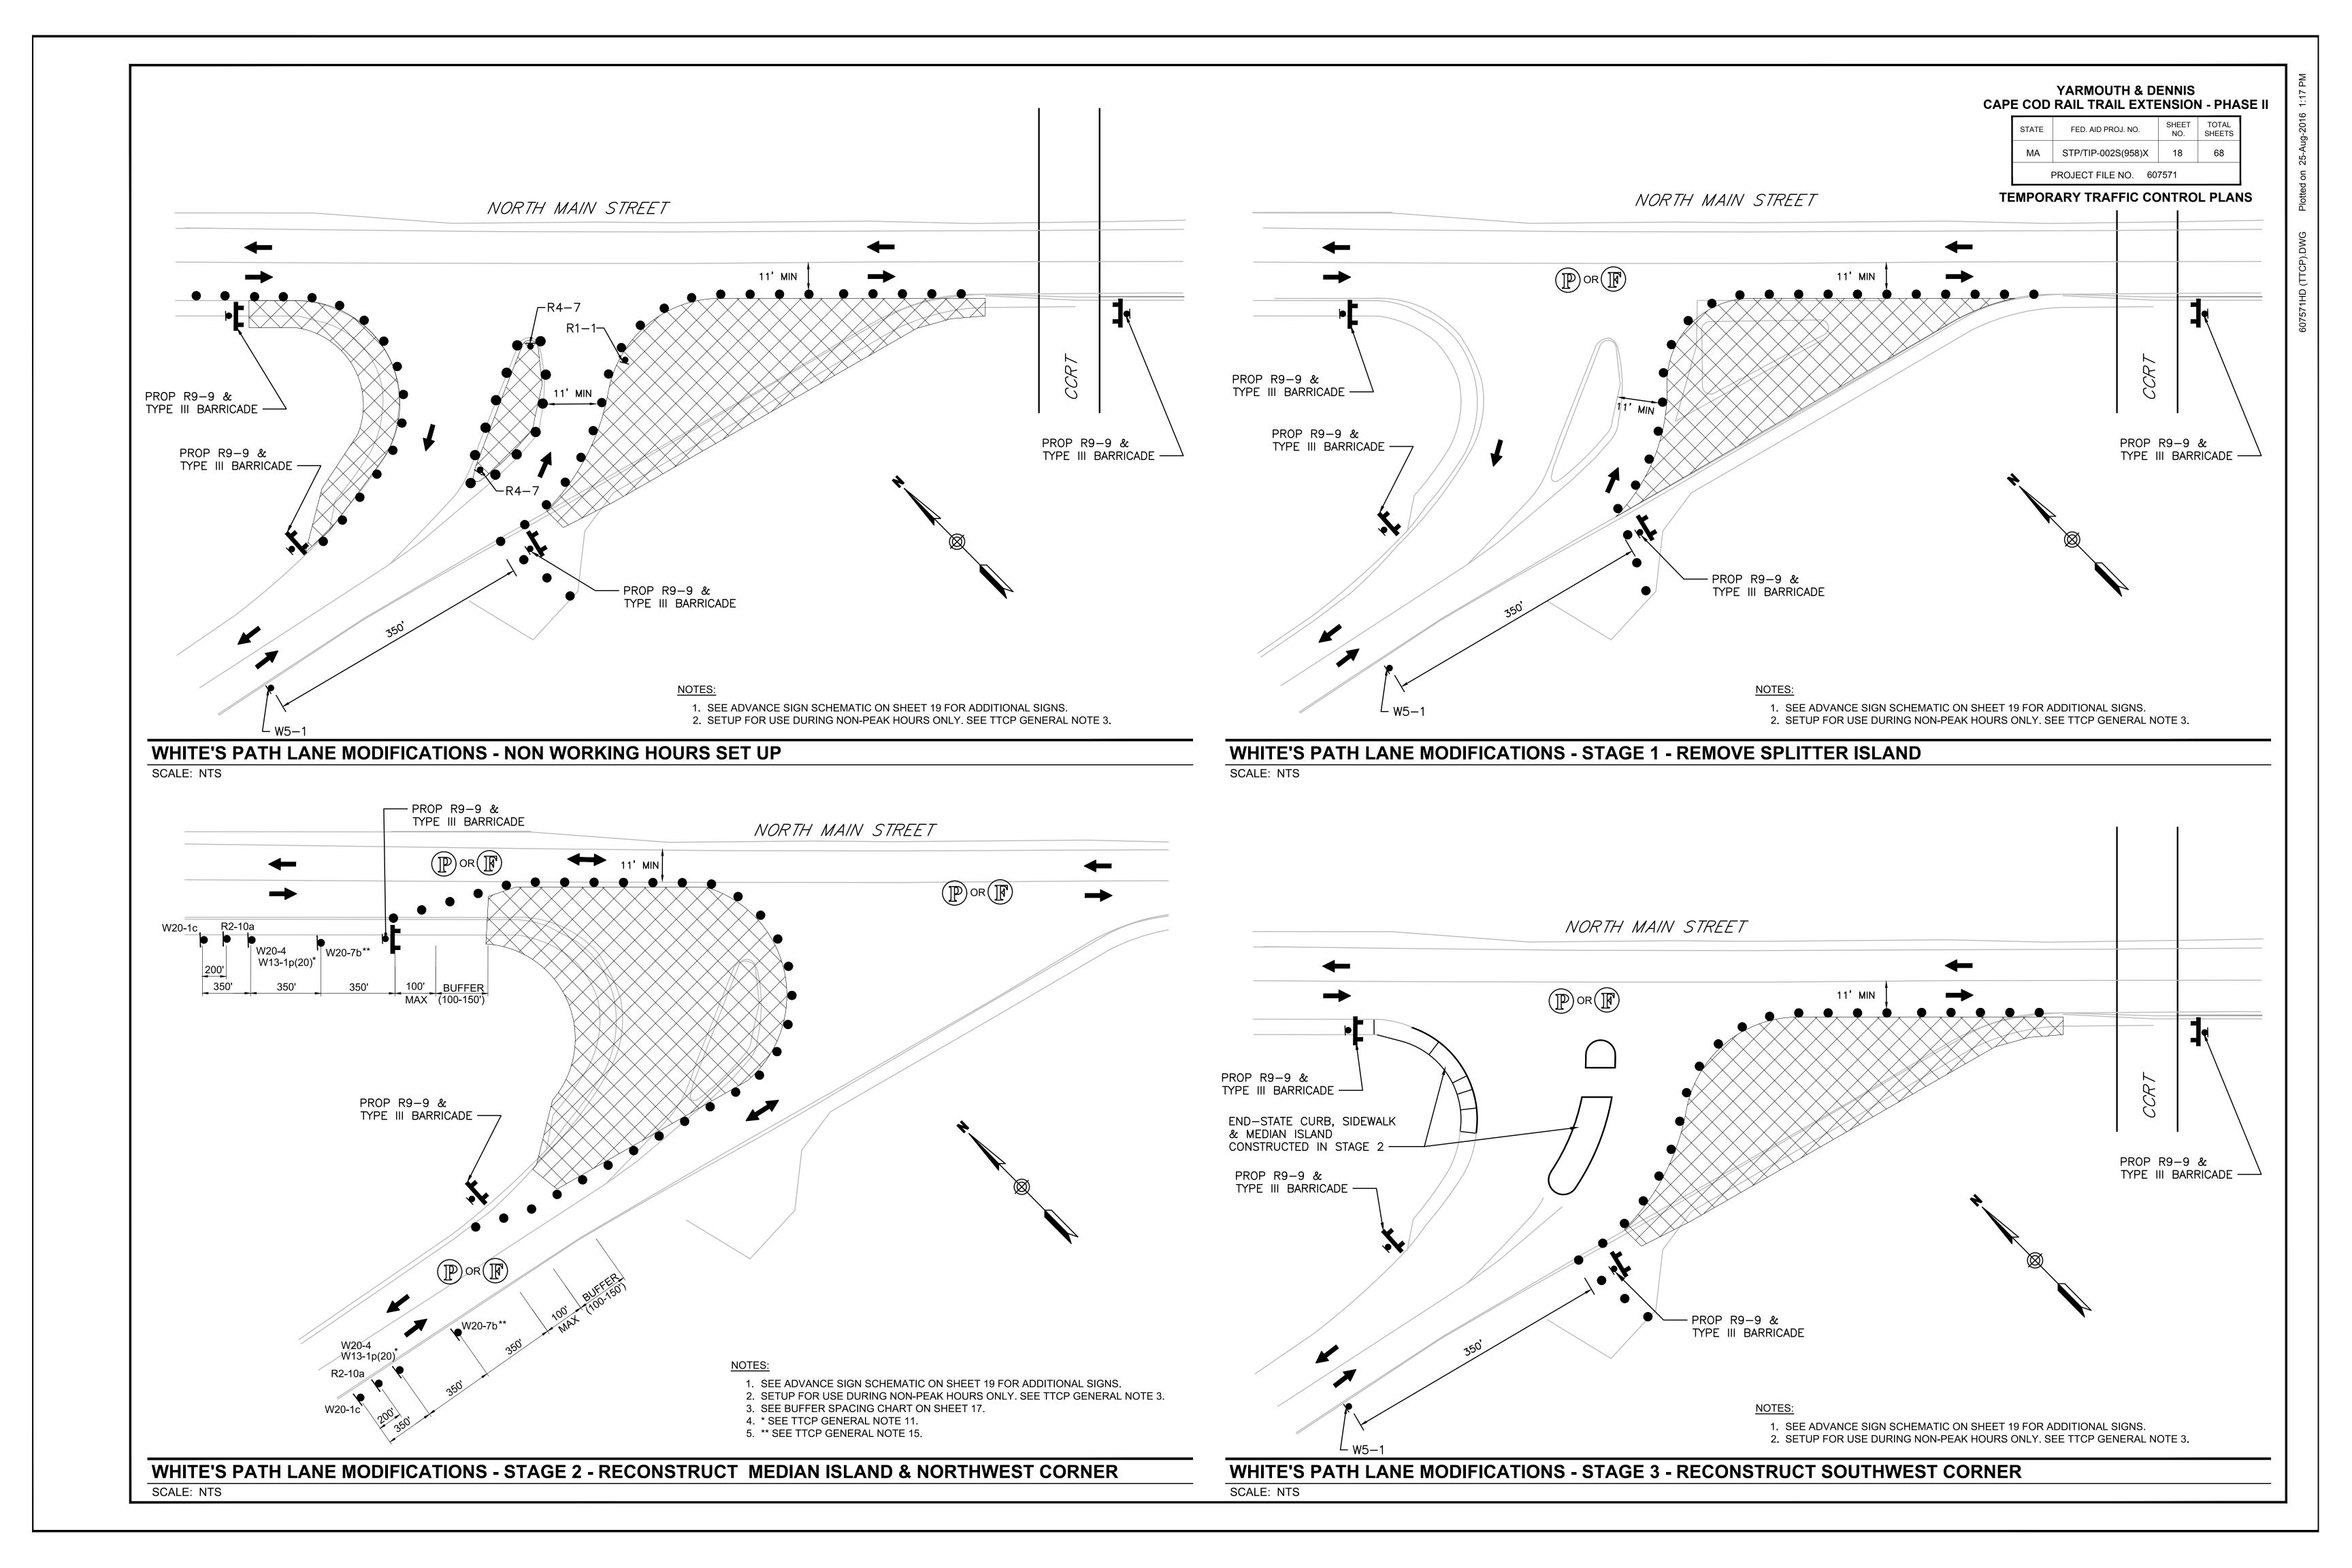

ADVANCE SIGN SCHEMATIC

SIGNS TO BE INSTALLED AT THE PROJECT LIMITS AS SHOWN. ALL ADVANCE SIGNS TO BE IN PLACE FOR THE DURATION OF THE PROJECT.

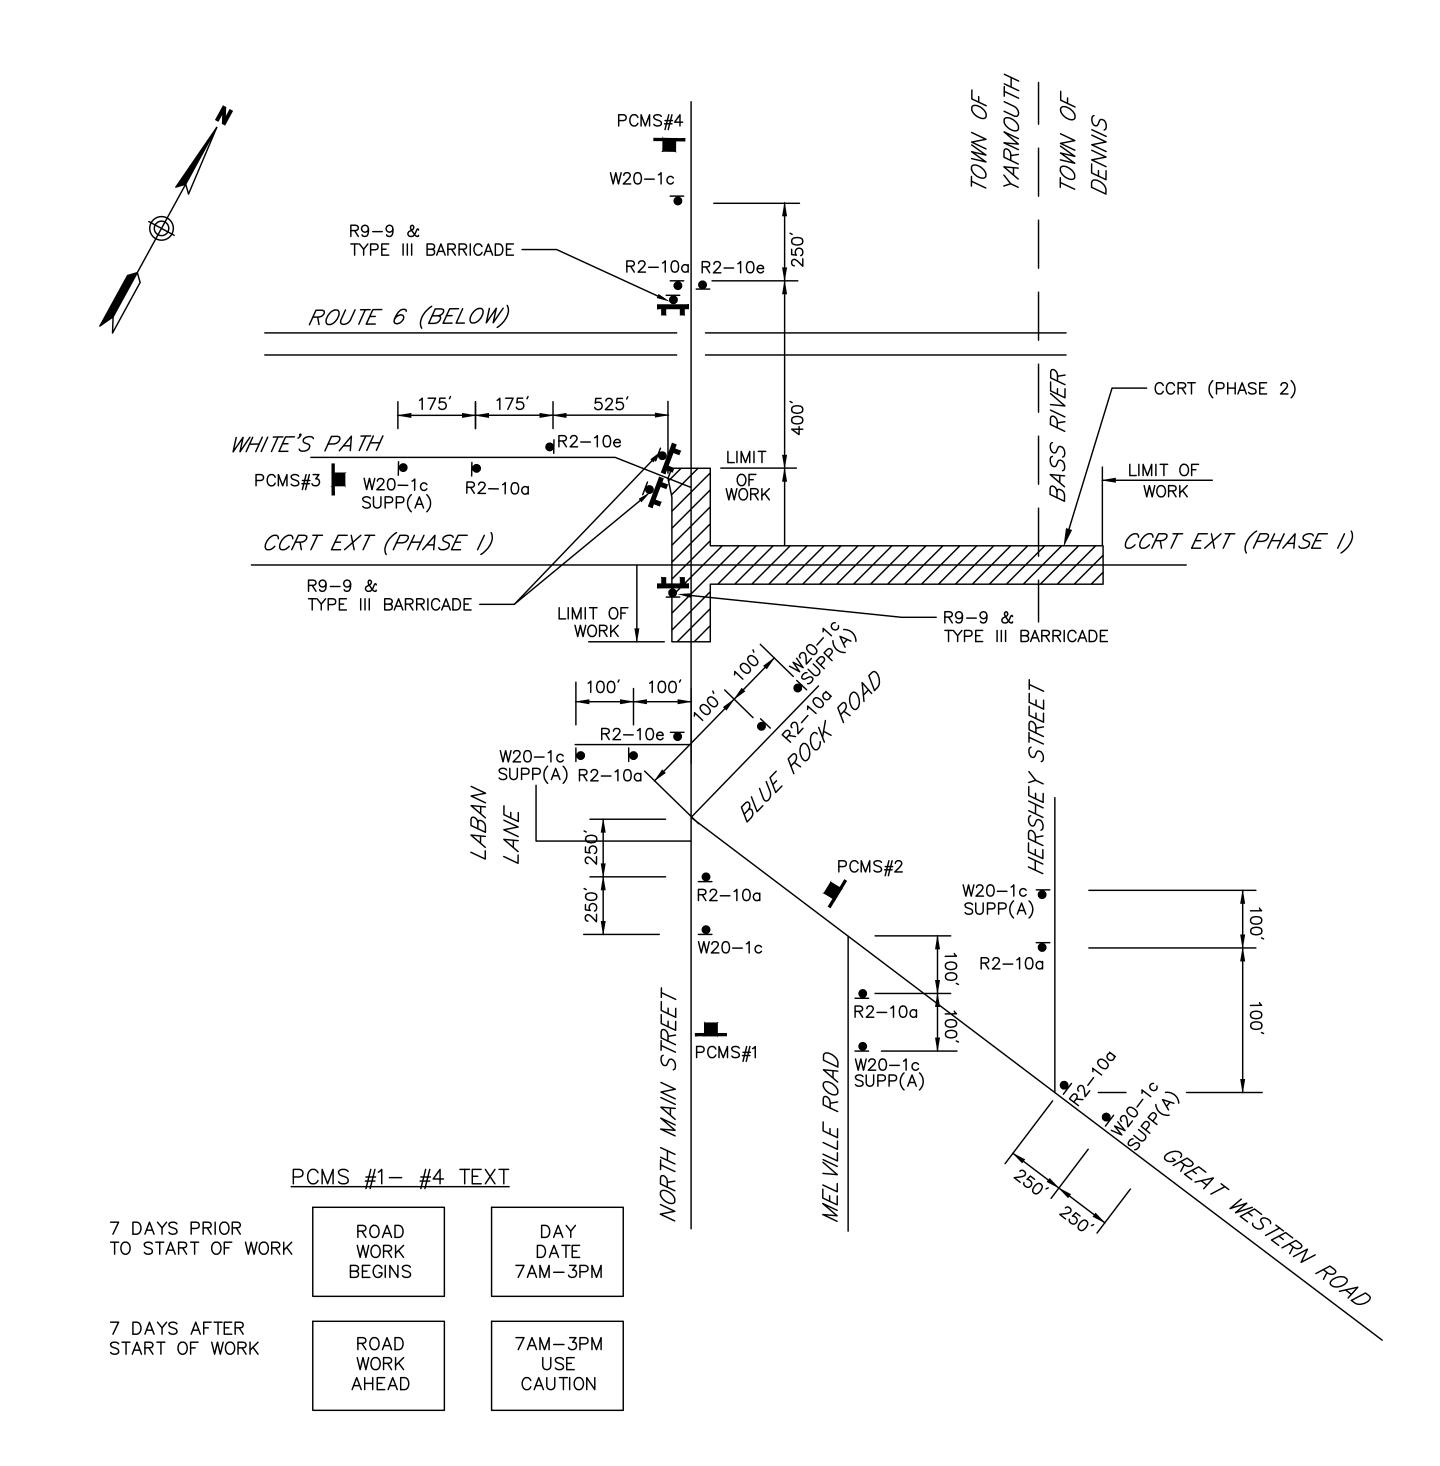

1. ADVANCE SIGNS TO BE INSTALLED AT THE PROJECT LIMITS AS

- 2. ALL ADVANCE SIGNS TO BE IN PLACE FOR THE DURATION OF THE PROJECT.
- 3. PCMS SHALL BE INSTALLED WITHIN THE EXISTING RIGHT-OF-WAY (ROW) OFF THE ROADWAY AT APPROXIMATE LOCATIONS SHOWN ÒR AS DIRECTED BY MASSDOT. PCMS SHALL NOT BE PLACED ON EXISTING SIDEWALK.
- 4. DAY AND DATE ON PCMS MESSAGING SHALL BE COORDINATED WITH MASSDOT.
- 5. CONTRACTOR SHALL PROVIDE PCMS A MINIMUM OF 7 DAYS PRIOR
- TO START OF CONSTRUCTION. 6. CONTRACTOR SHALL REMOVE ALL PCMS SHOWN 7 DAYS AFTER THE START OF CONSTRUCTION UNLESS OTHERWISE DIRECTED BY THE ENGINEER.

TEMPORARY TRAFFIC CONTROL SIGN SUMMARY

IDENTIFI—	SIZE OI	F SIGN			COLOR		TEXT DIME	vsions ((INCHES)	NUMBER OF	UNIT	AREA IN SQUARE
CATION NUMBER	HEIGHT	WIDTH	TEXT	BACK- GROUND	LEGEND	BORDER	LETTER V HEIGHT S	ERTICAL PACING	ARROW RTE. MKR.	SIGNS REQUIRED	AREA (S.F.)	FEET
R1-1	30″	30″	STOP	RED	WHITE	WHITE	SEE MANU TRAFFIC CON STREETS	TROL DE	VICES FOR	1	5.18	5.18
R2-10a	48"	36″	WORK ZONE SPEEDING FINES DOUBLED	FLOURESCENT ORANGE WHITE	BLACK	BLACK	SEE MASS	DOT STA	NDARDS	11	12.00	132.00
R2-10e	36″	48″	END ROAD WORK DOUBLE FINES END	FLOURESCENT ORANGE WHITE	BLACK	BLACK	SEE MASS	DOT STA	NDARDS	6	12.00	72.00
R4-7	30″	24″		WHITE	BLACK	BLACK	SEE MANU TRAFFIC CON STREETS	TROL DE	VICES FOR	2	5.00	10.00
R9-9	18″	30″	SIDEWALK CLOSED	WHITE	BLACK	BLACK				5	3.75	18.75
W5-1	36″	36″	ROAD NARROWS	FLOURESCENT ORANGE	BLACK	BLACK			1	9.00	9.00	
W8-15	36″	36″	GROOVED PAVEMENT	FLOURESCENT ORANGE	BLACK	BLACK			3	9.00	27.00	
W13-1(20)	24"	24″	20 MPH	FLOURESCENT ORANGE	BLACK	BLACK				3	4.00	12.00
W20-8a	36″	36″	RAISED UTILITIES CASTING	FLOURESCENT ORANGE	BLACK	BLACK				3	9.00	27.00
W20-1c	36"	36″	ROAD WORK AHEAD	FLOURESCENT ORANGE	BLACK	BLACK				11	9.00	99.00
W20-4	36″	36″	ONE LANE ROAD AHEAD	FLOURESCENT ORANGE	BLACK	BLACK		V		3	9.00	27.00
W20-7	36″	36″		FLOURESCENT ORANGE	BLACK	BLACK	SEE MASS	DOT STA	NDARDS	3	9.00	27.00
W20-7b	36″	36"	POLICE OFFICER AHEAD	FLOURESCENT ORANGE	BLACK	BLACK	SEE MASS	DOT STA	NDARDS	3	9.00	27.00
SUPP(A)	12″	36″	N. MAIN ST	FLOURESCENT ORANGE	BLACK	BLACK	SEE MANU TRAFFIC CON STREETS	TROL DE	VICES FOR	6	3.00	18.00

NOTE: HIGH INTENSITY REFLECTIVE SHEETING SHALL BE USED FOR ALL SIGNS.

			LANDSCAPE PLANT LIST					YARMOUTH & DENNIS
ABEL	SYMBOL	BOTANICAL NAME	COMMON NAME	UNIT	UANTITY	SI□E	REMARKS	CAPE COD RAIL TRAIL EXTENSION - PI
AC	\odot	AMELANCHIER CANADENSIS	SHAD TREE	EA	4	4-5'	ORNAMENTAL TREE	STATE FED. AID PROJ. NO. SHEET NO. SHEET NO. SHEET NO.
HV	\odot	HAMAMELIS VIRGINIANA	WITCH HADEL SPRING BLOOMING	EA	1	2-3' HT	SHRUB	MA STP/TIP-002S(958)X 20 68
PS	₩	PINUS STROBUS	PINE WHITE	EA	8	5-6' H	EVERGREEN TREE	PROJECT FILE NO. 607571 LANDSCAPE PLANS & DETAILS
0	₩	THUJA OCCIDENTALIS (NIGRA)	ARBORVITAE - DARK AMERICAN	EA	4	5-6'	EVERGREEN TREE	LANDOON LI LANG & BLIME
SHALL	L RECEIVE A 2	HIN LIMIT OF WORK NOT COVERED WITH STRUCTURE 2-IN LAYER OF COMPOST TOPSOIL AND SEED CONTINUES ARE PER SHEET.	OVER A 4-IN LAYER OF LOAM.	IY OR CANCHORI	PPED)	150; 000; 150;	IMIT OF WORK STA 900+50.00	MID-CAPE HIGHWAY (ROUTE 6) STA 901-22-19 NORTH MAIN ST &
	N/F ROBERT A.M. P.O. BOX 153 D.B. 8795, MA D.B. 8795, PG.	7. 110-7 OUR CO., INC. WHITES PATH, LLC 39 O2645-6536 D.B. 20805, PG. 238 O2664	238		239 •		M/F SOMMONWEALTH OF MASSACHUSETTS OR BOSTON, MA OX202 D.B. 3498, PG. 092	N/F MCHELLE AM. 100-39 SOUTH OF THE POWERS SOUTH OF THE PO
		N/F TOWN 1146 R SOUTH D.B. 129	OF YARMOUTH YARMOUTH MA 02664			N/F THOMAS 66 LAKI DIO4799	TOWN 1146	DUTH, MA 02664 $/$ $/$ $/$ $/$ $/$ $/$ $/$ $/$ $/$ $/$

OVERALL LANDSCAPE PLAN

<u>PLAN</u>

SCALE IN FEET

YARMOUTH & DENNIS CAPE COD RAIL TRAIL EXTENSION - PHASE II


STATE FED. AID PROJ. NO. SHEET TOTAL SHEETS

MA STP/TIP-002S(958)X 21 68

PROJECT FILE NO. 607571

LANDSCAPE PLANS & DETAILS



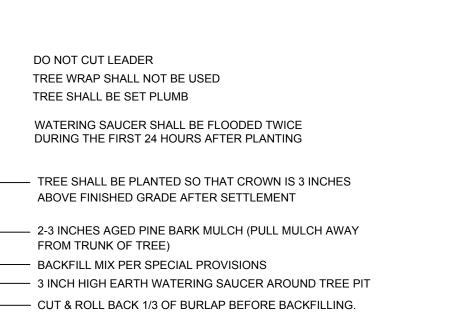

COMPLETELY REMOVE SYNTHETIC BURLAP & LACING

- ROOTBALL SHALL BE PLACED ON


UNDISTURBED SUBGRADE

6 INCHES
BELOW
ROOTBALL
ROOTBALL

NOT TO SCALE

DECIDUOUS TREE PLANTING

MIN. 2 X ROOTBALL DIAMETER

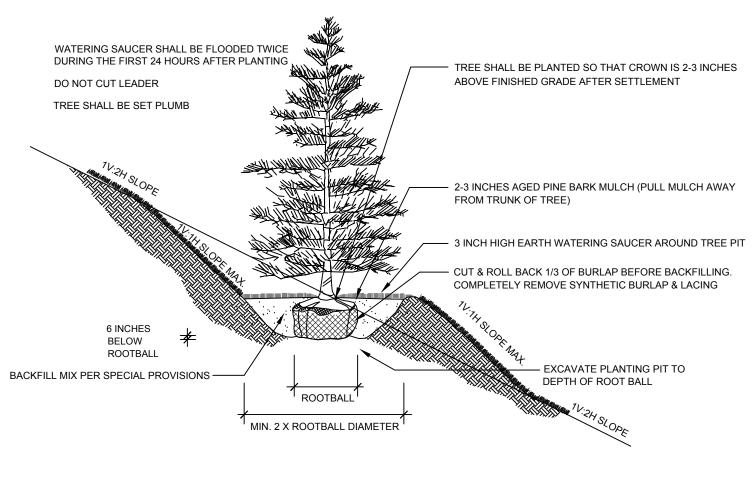

— 2-3 INCHES AGED PINE BARK MULCH (PULL MULCH AWAY

— 3 INCH HIGH EARTH WATERING SAUCER AROUND TREE PIT

CUT & ROLL BACK 1/3 OF BURLAP BEFORE BACKFILLING.
 COMPLETELY REMOVE SYNTHETIC BURLAP & LACING

FROM TRUNK OF TREE)

BACKFILL MIX PER SPECIAL PROVISIONS

– ROOTBALL SHALL BE PLACED ON UNDISTURBED SUBGRADE

WATERING SAUCER SHALL BE FLOODED TWICE

DURING THE FIRST 24 HOURS AFTER PLANTING

6 INCHES BELOW

ROOTBALL

NOT TO SCALE

1 ROOTBALL

1_{MIN. 2 X ROOTBALL DIAMETER}1

EVERGREEN TREE PLANTING


TREE SHALL BE SET PLUMB

TREE SHALL BE PLANTED SO THAT CROWN IS 3 INCHES ABOVE

FINISHED GRADE AFTER SETTLEMENT

DO NOT CUT LEADER




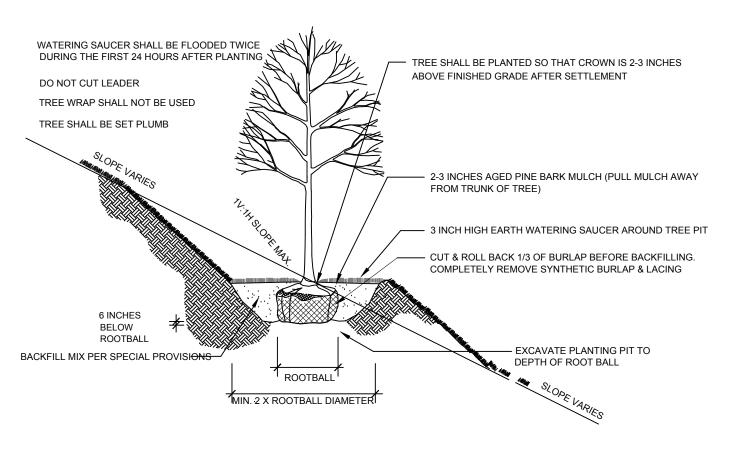



DECIDUOUS TREE PLANTING (SLOPE)


NOT TO SCALE

	MASTER PLANT SUMMARY LIST							
QTY.	KEY	BOTANICAL NAME	COMMON NAME	UNIT.	SIZE	SPACING		
EVERG	REEN TRI	EES	1					
13	PS	PINUS STROBUS	PINE WHITE	EA	5-6'H	10 FT O.C.		
4	ТО	THUJA OCCIDENTALIS (NIGRA)	ARBORVITAE -DARK AMERICAN	EA	5'-6'	10 FT O.C.		
SHADE	TREES							
4	AC	AMELANCHIER CANADENSIS	SHAD TREE	EA	4-5'	12 FT O.C.		
6	HV	HAMAMELIS VIRGINIANA	WITCH HAZEL SPRING BLOOMING	EA	2-3' HTL	12 FT O.C.		

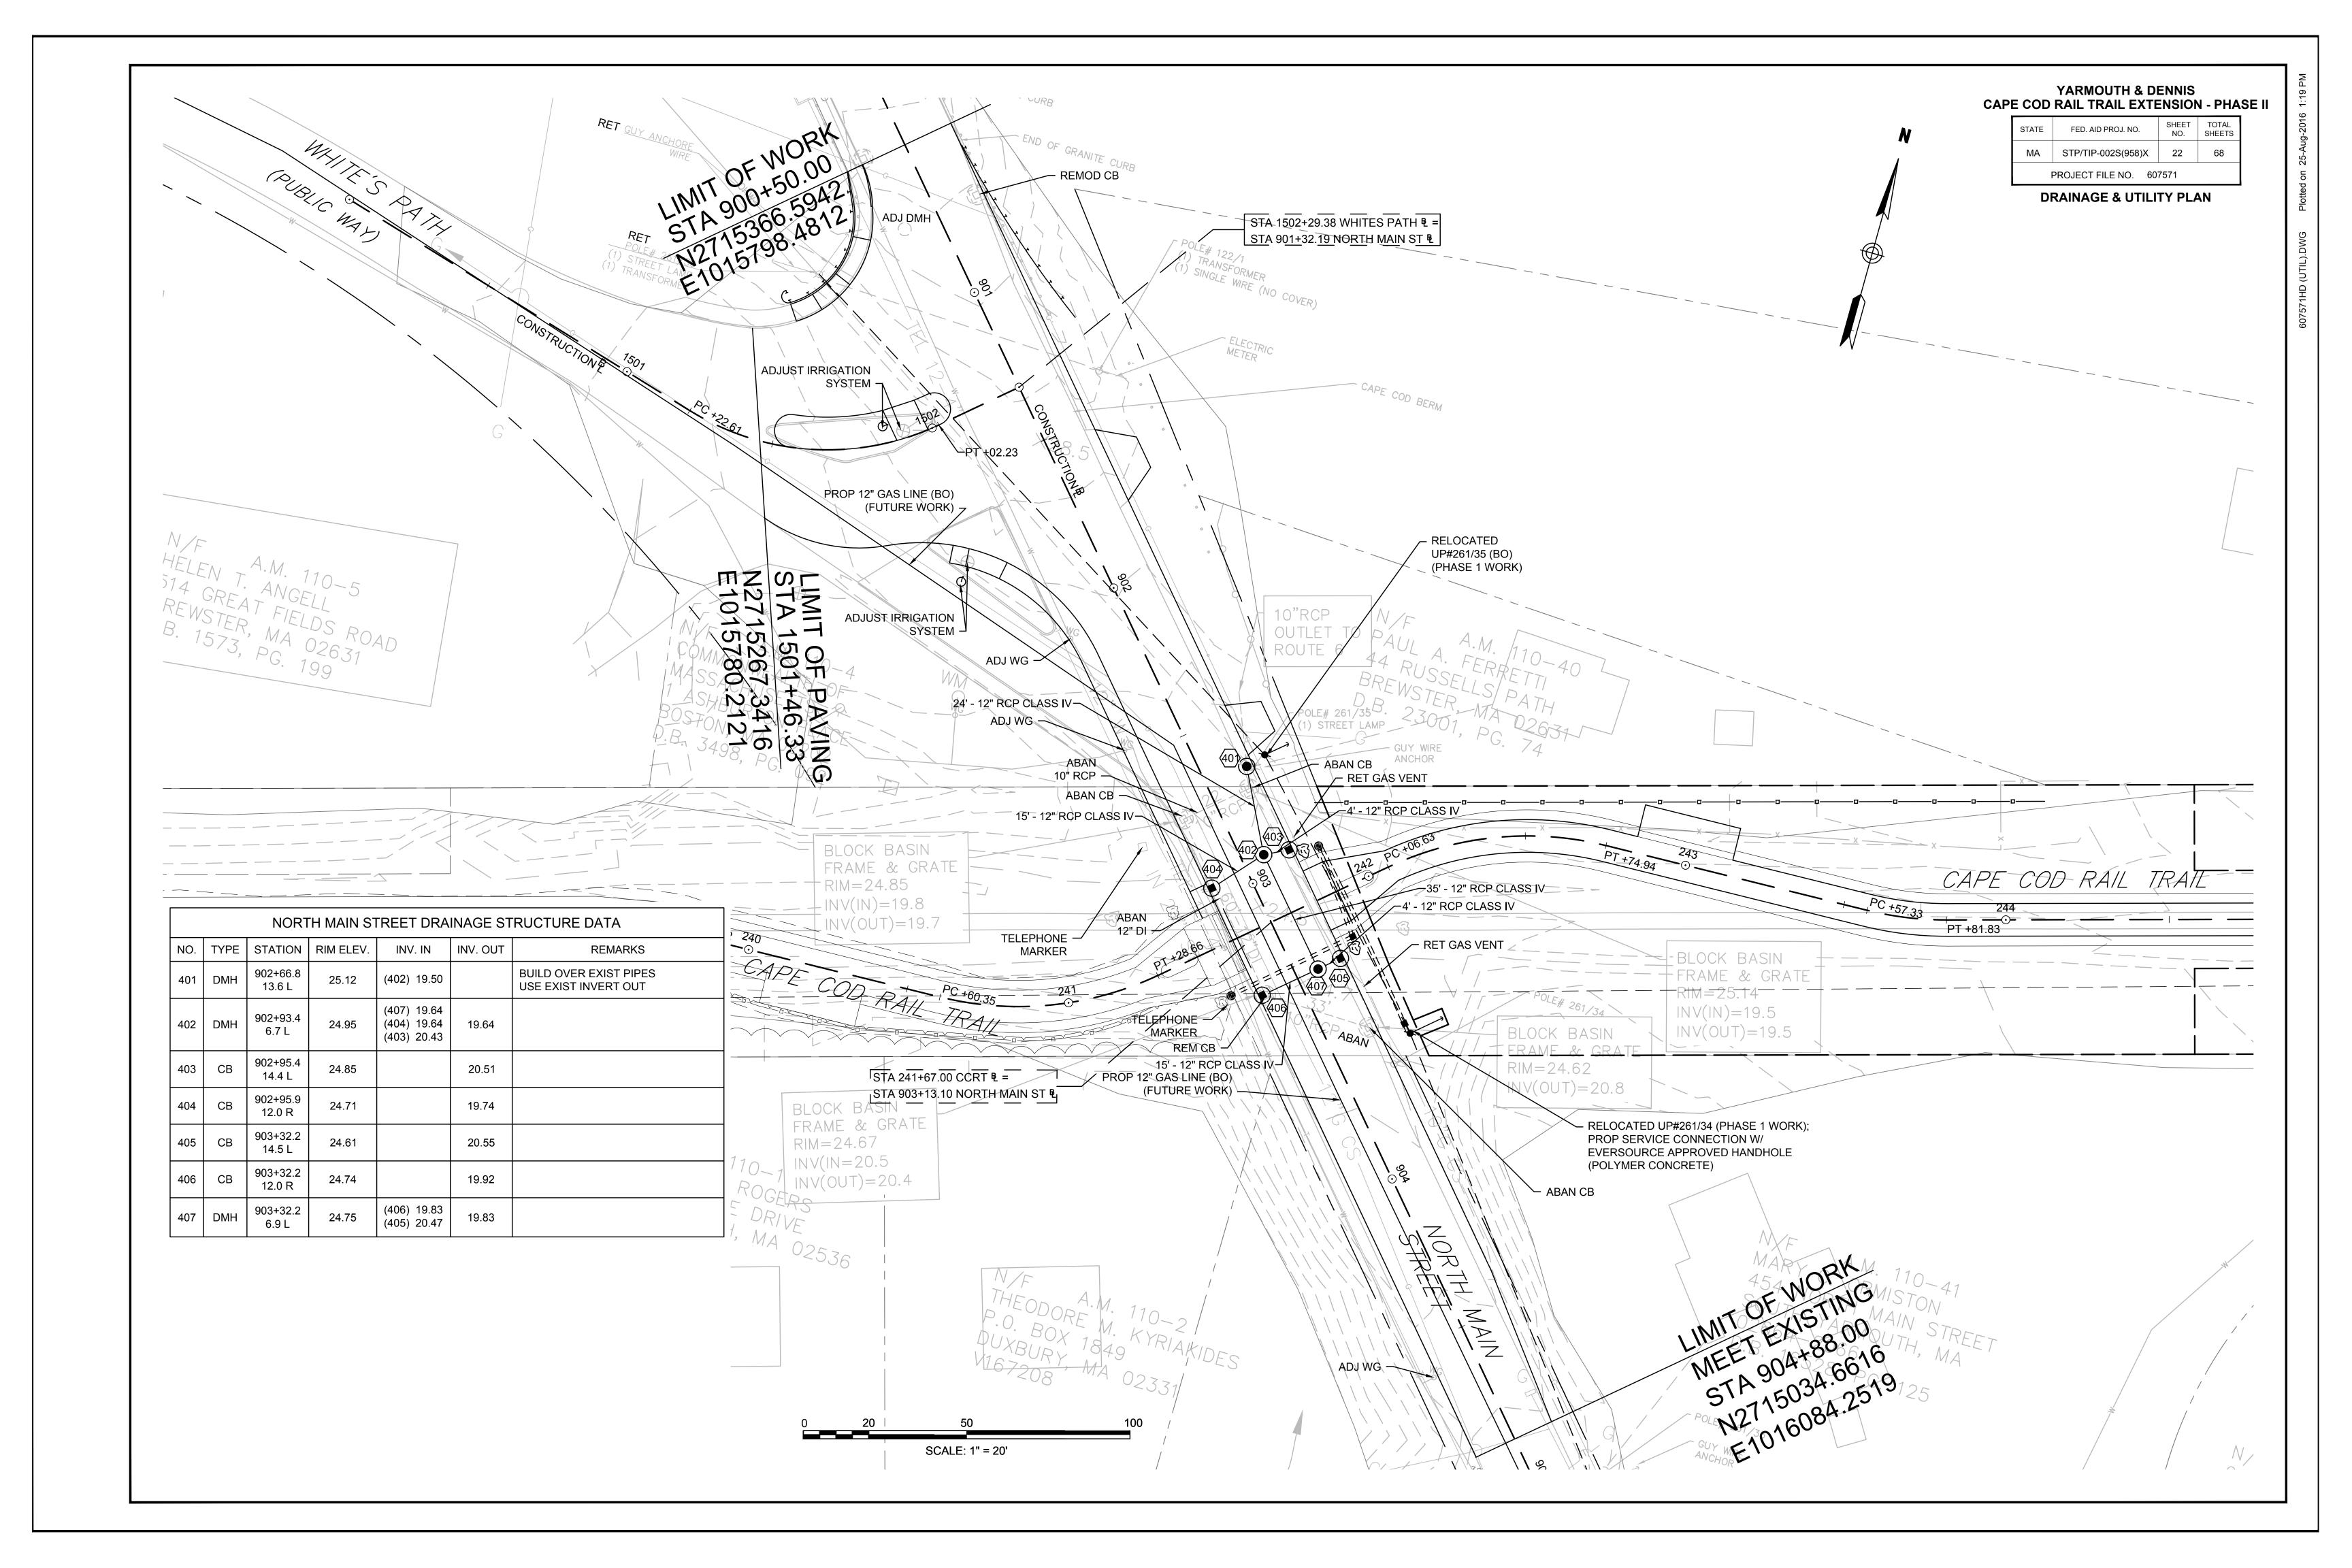


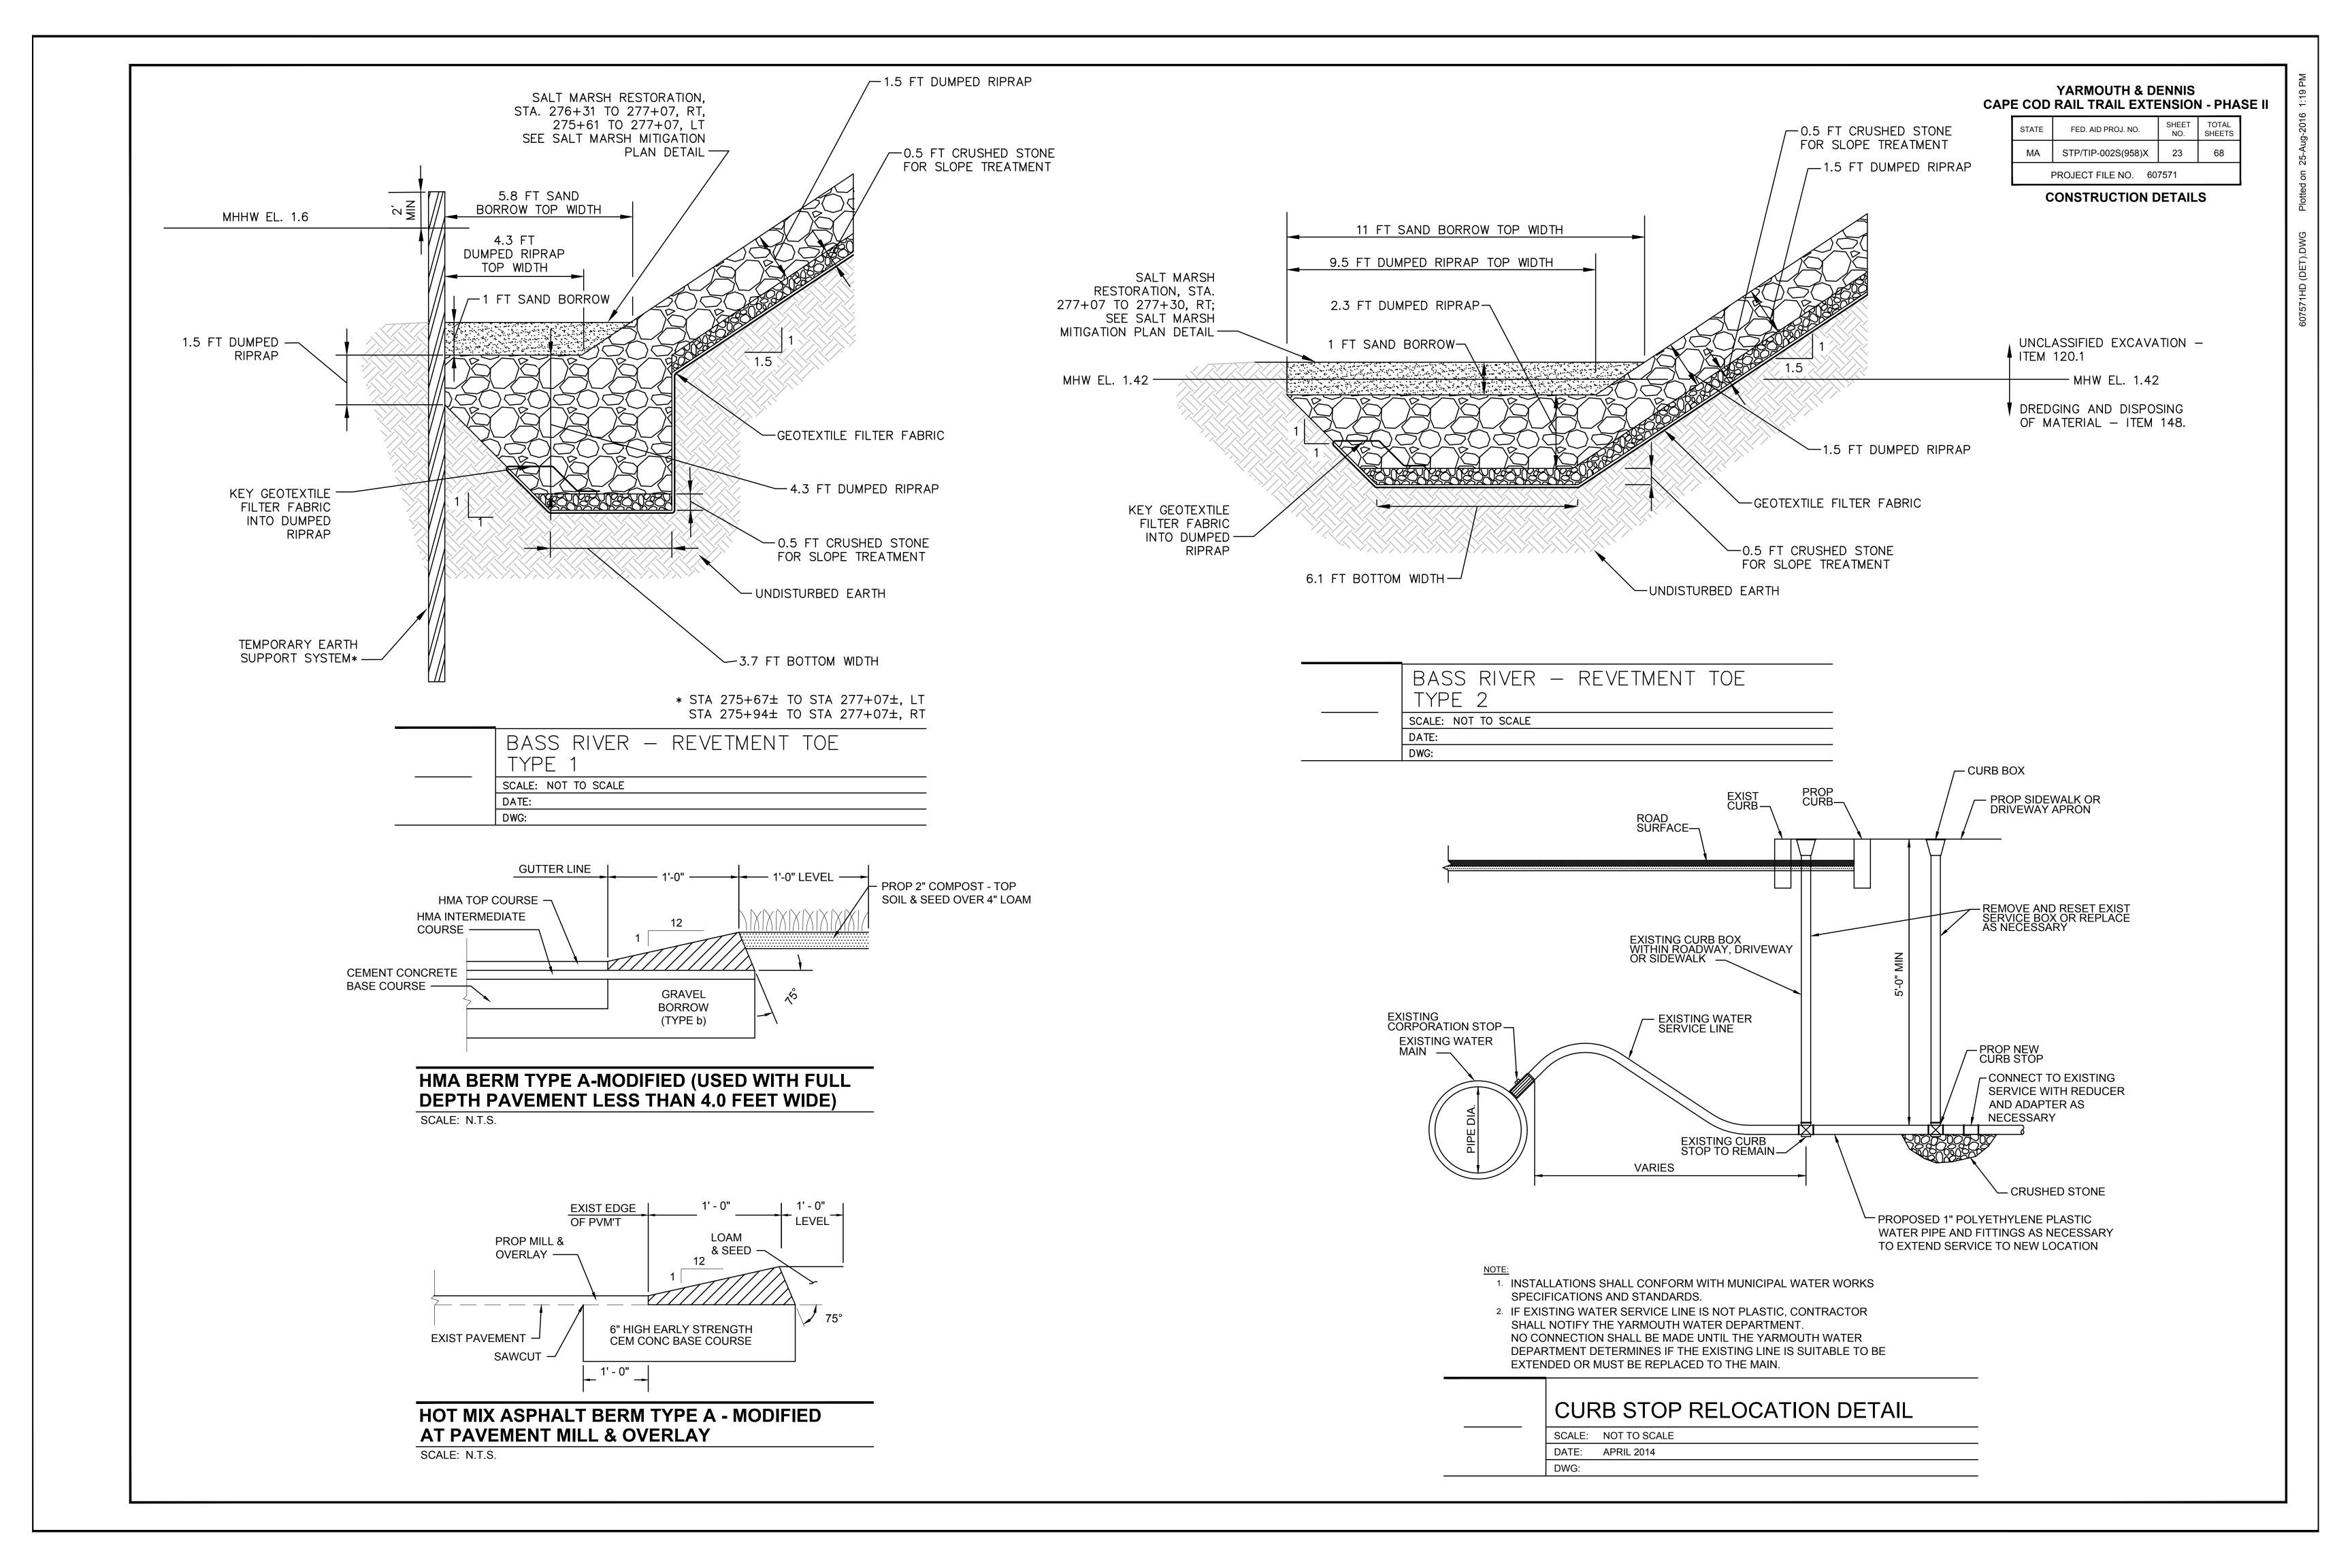

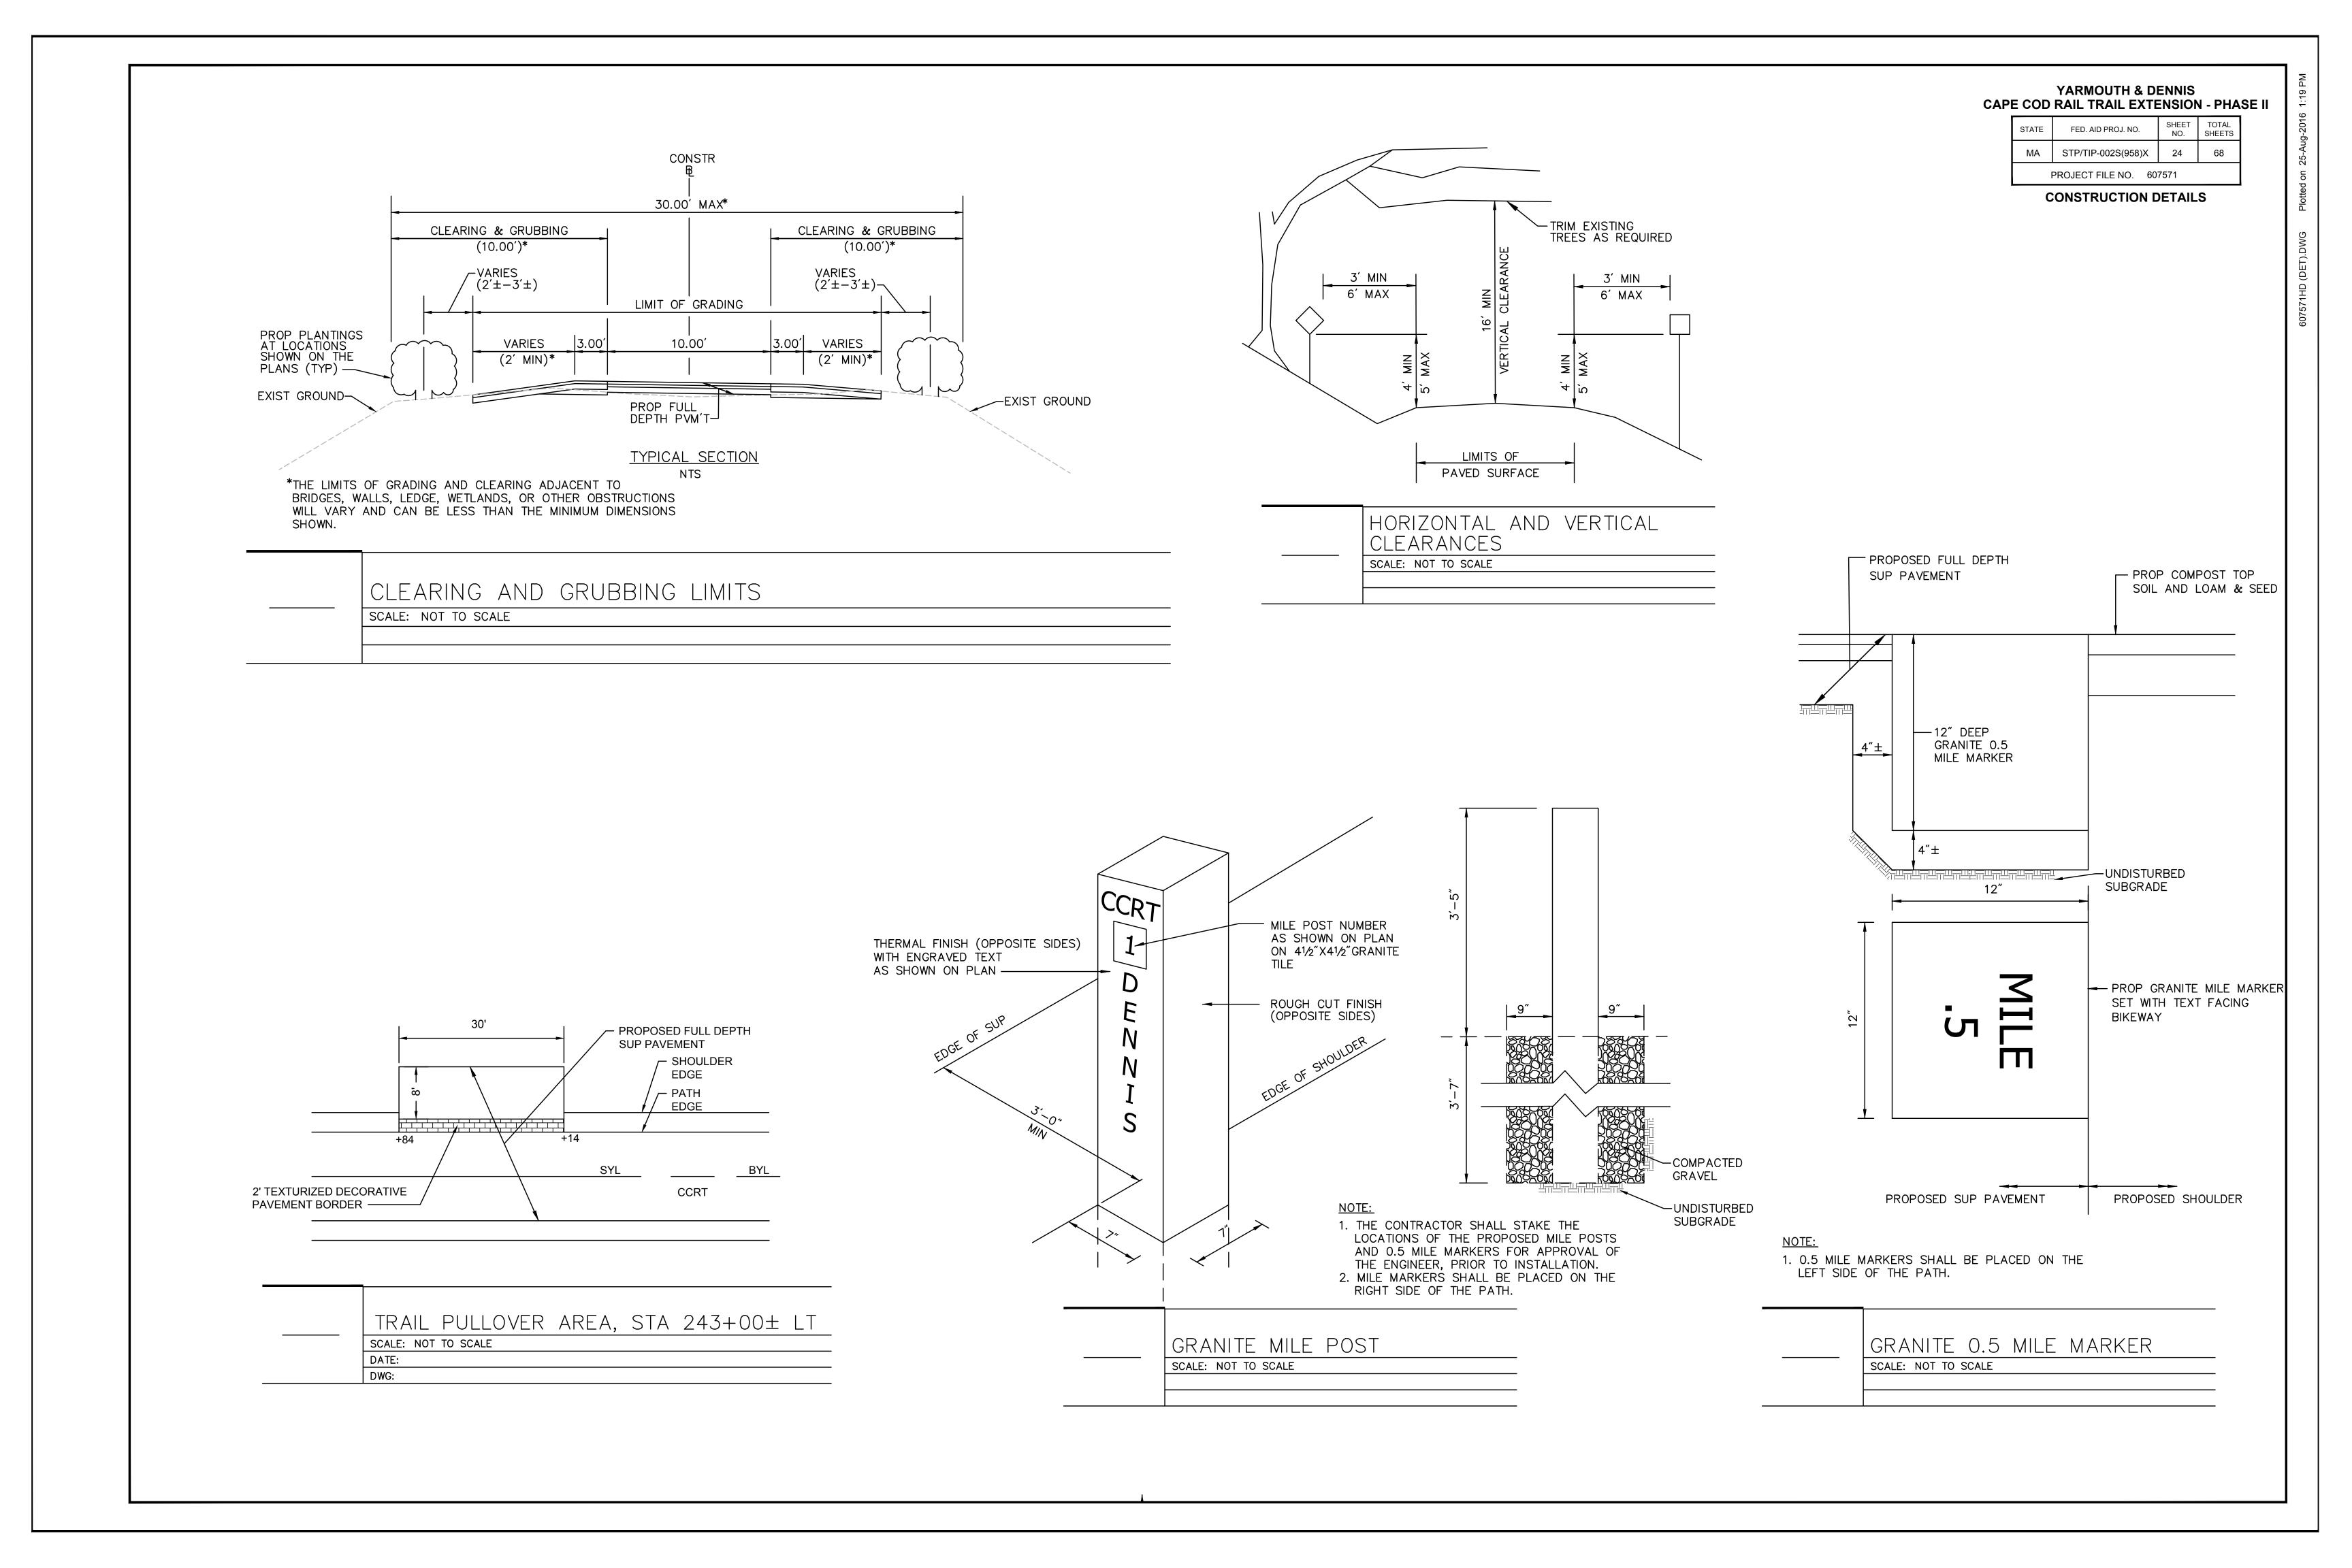

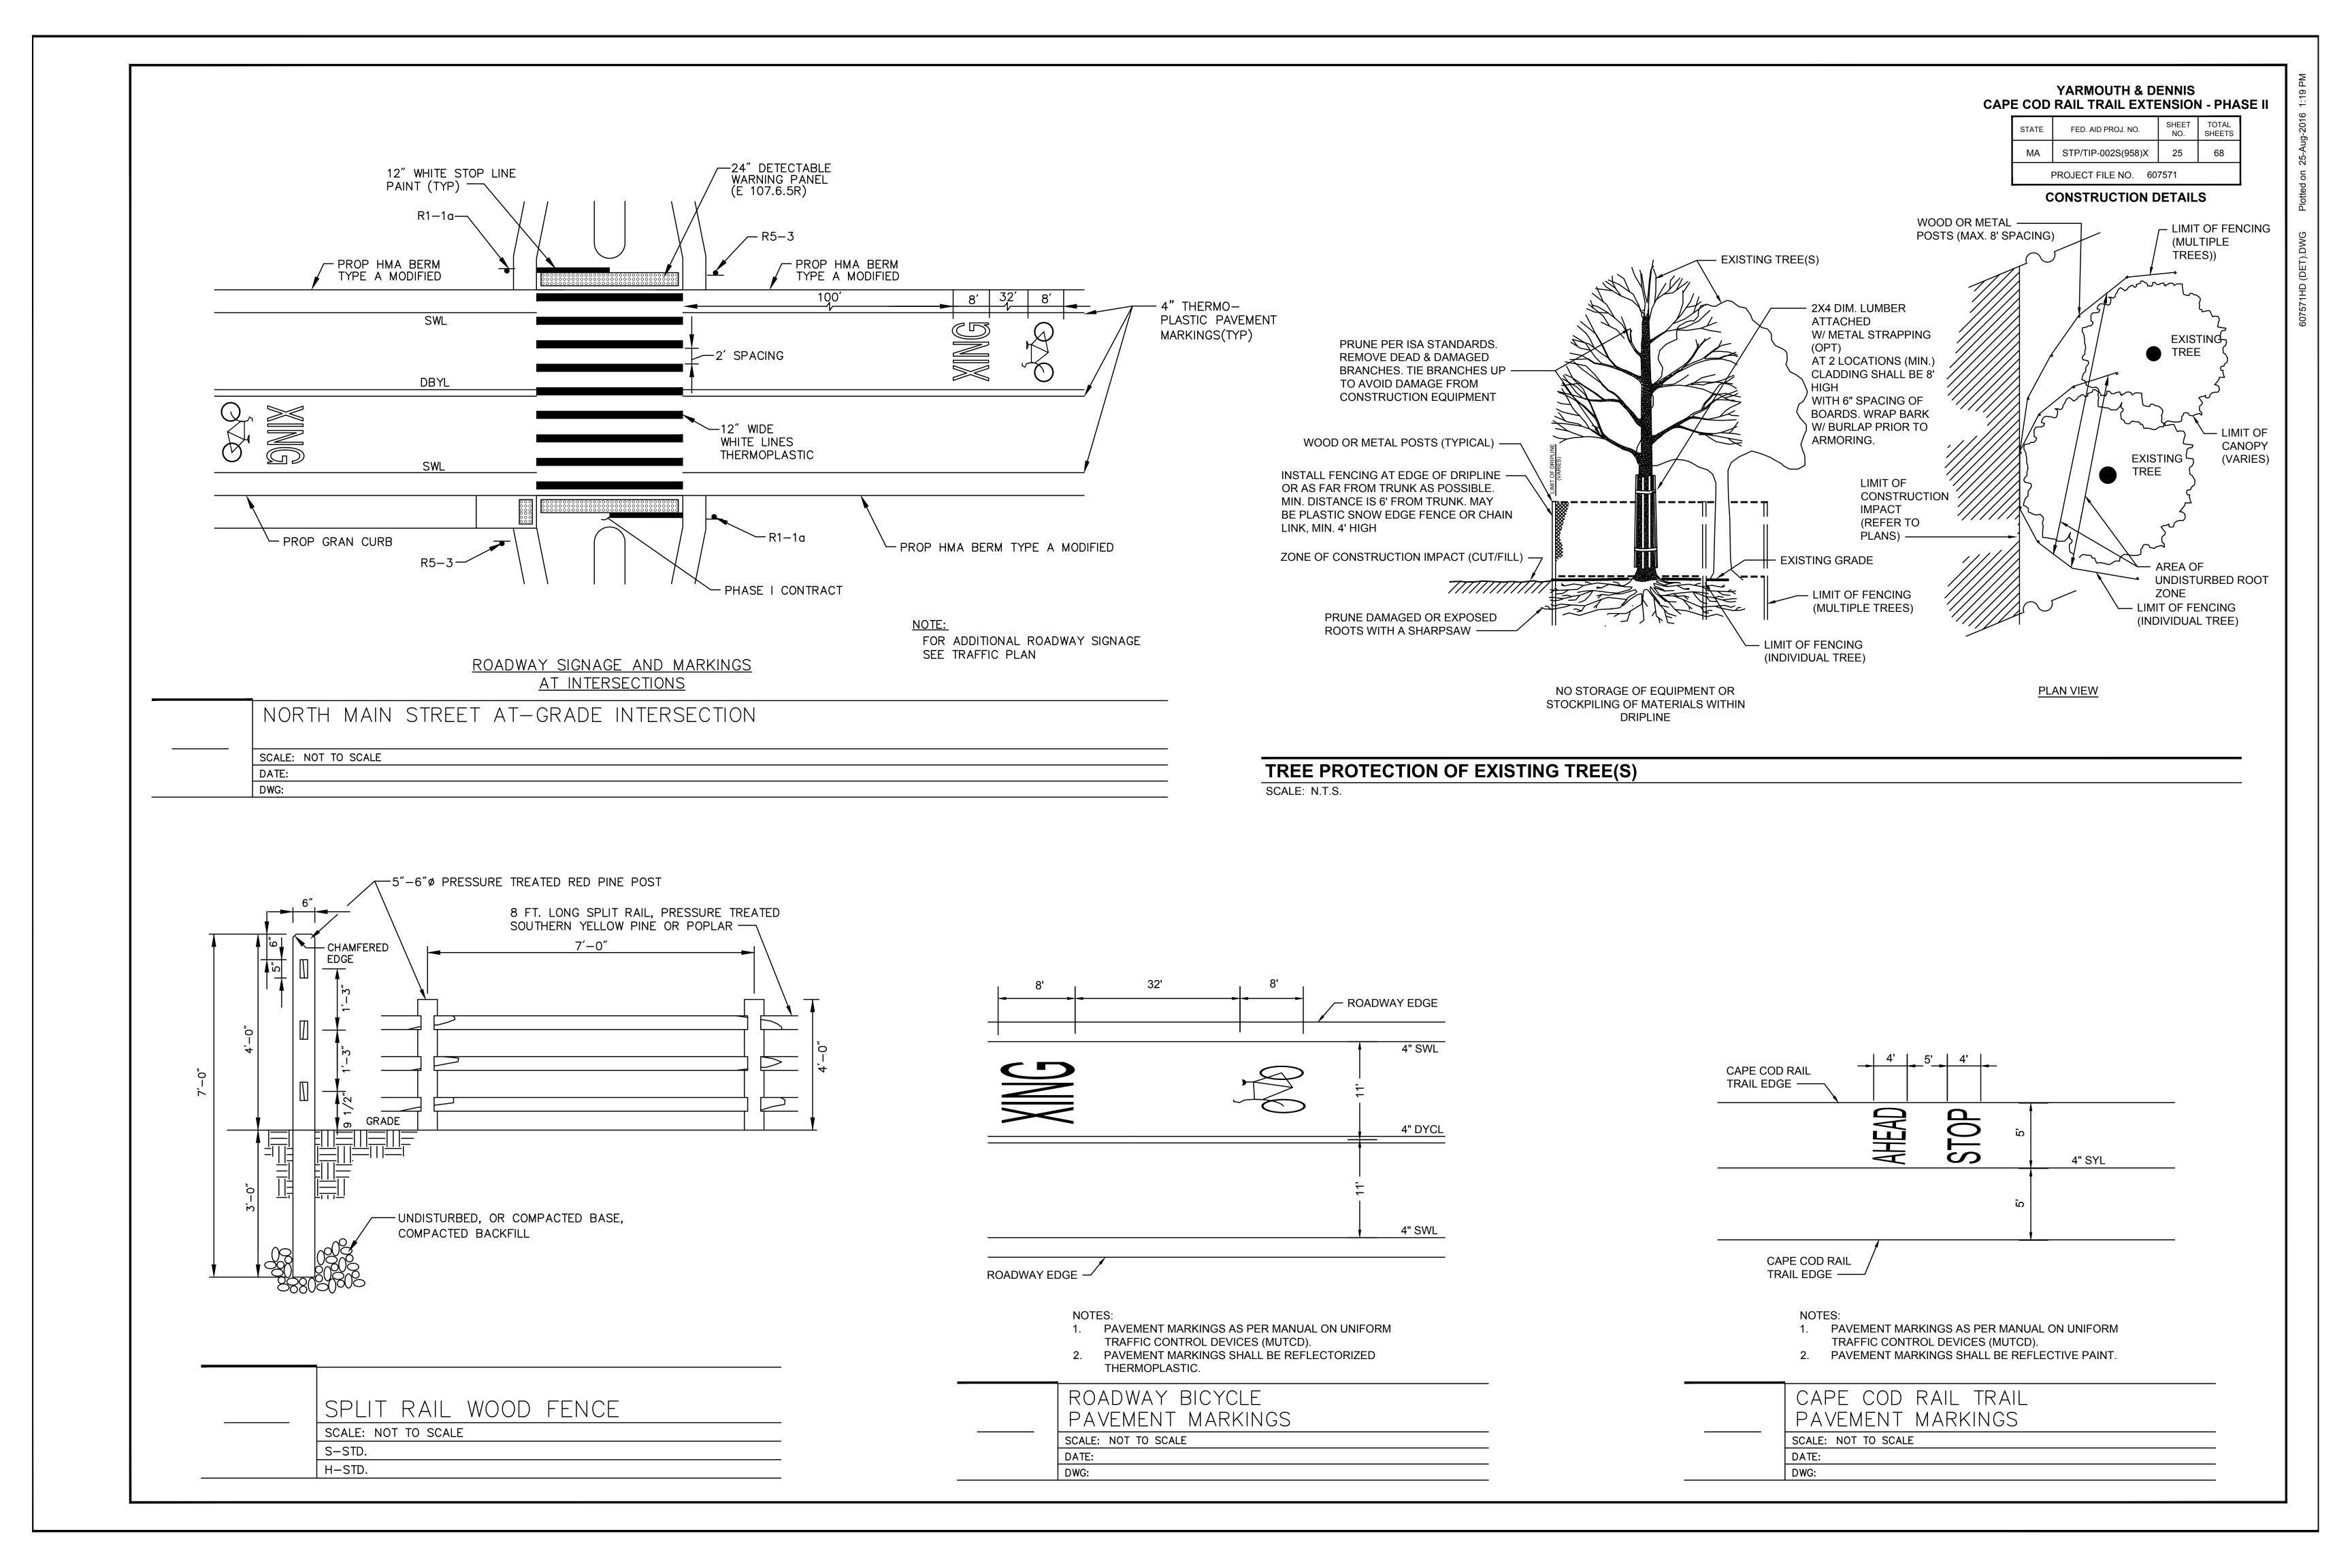

CONSTRUCTION DETAILS

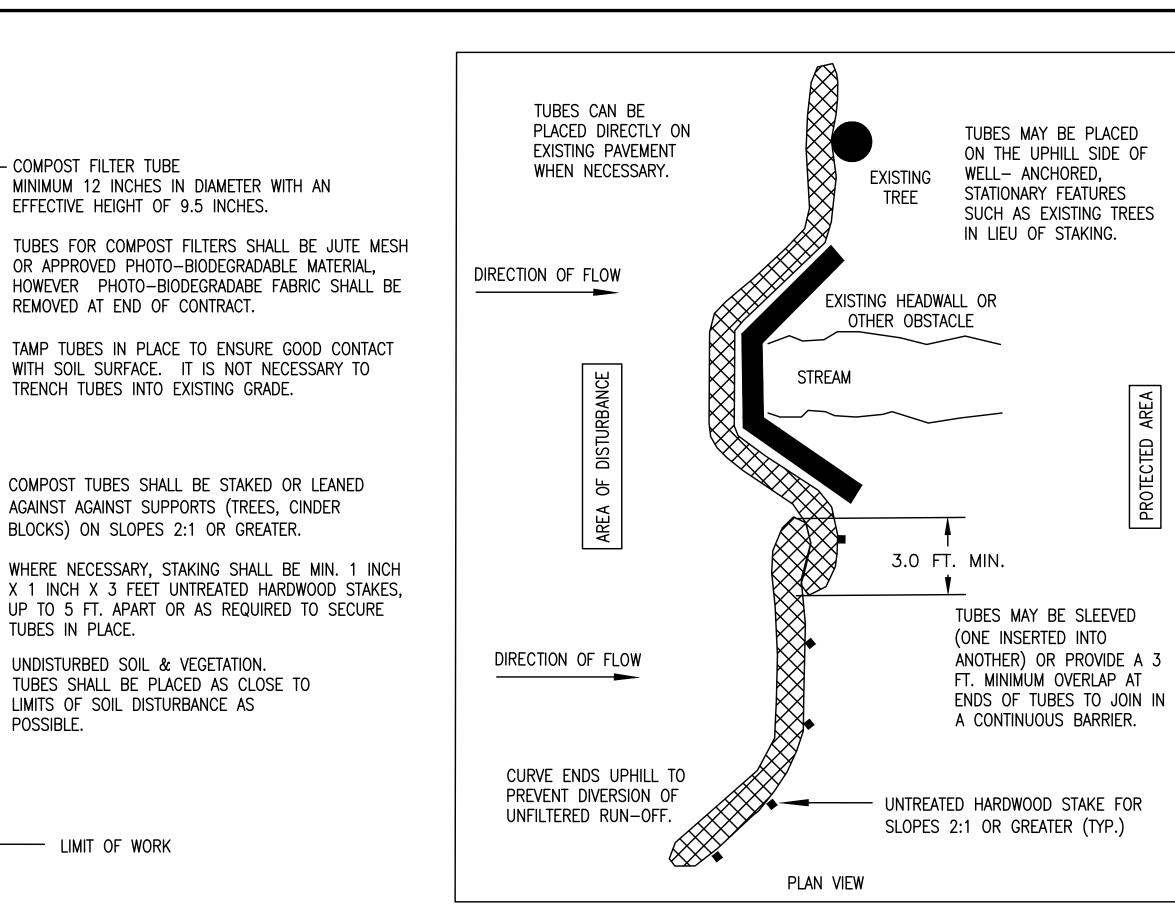

GENERAL NOTES:

- 1. PROVIDE A MINIMUM TUBE DIAMETER OF 12 INCHES FOR SLOPES UP TO 50 FEET IN LENGTH WITH A SLOPE RATIO OF 3H:1V OR STEEPER. LONGER SLOPES OF 3H:1V MAY REQUIRE LARGER TUBE DIAMETER OR ADDITIONAL COURSING OF FILTER TUBES TO CREATE A FILTER BERM. REFER TO MANUFACTURER'S RECOMMENDATIONS FOR SITUATIONS WITH LONGER OR STEEPER SLOPES.
- 2. INSTALL TUBES ALONG CONTOURS AND PERPENDICULAR TO SHEET OR CONCENTRATED
- 3. TUBE LOCATION MAY BE SHIFTED TO ADJUST TO LANDSCAPE FEATURES, BUT SHALL PROTECT UNDISTURBED AREA AND VEGETATION TO MAXIMUM EXTENT POSSIBLE. 4. DO NOT INSTALL IN PERENNIAL, EPHEMERAL
- OR INTERMITTENT STREAMS.
- 5. ADDITIONAL TUBES SHALL BE USED AT THE DIRECTION OF THE ENGINEER.
- 6. ADDITIONAL STAKING SHALL BE USED AT THE DIRECTION OF THE ENGINEER.

COMPOST FILTER TUBE

- COMPOST FILTER TUBE

MINIMUM 12 INCHES IN DIAMETER WITH AN

OR APPROVED PHOTO-BIODEGRADABLE MATERIAL,

COMPOST TUBES SHALL BE STAKED OR LEANED

AGAINST AGAINST SUPPORTS (TREES, CINDER

BLOCKS) ON SLOPES 2:1 OR GREATER.

UNDISTURBED SOIL & VEGETATION.

LIMITS OF SOIL DISTURBANCE AS

— LIMIT OF WORK

TUBES SHALL BE PLACED AS CLOSE TO

TUBES IN PLACE.


POSSIBLE.

EFFECTIVE HEIGHT OF 9.5 INCHES.

REMOVED AT END OF CONTRACT.


TRENCH TUBES INTO EXISTING GRADE.


SCALE: NOT TO SCALE DATE: 6-13-2014 (MASSDOT)

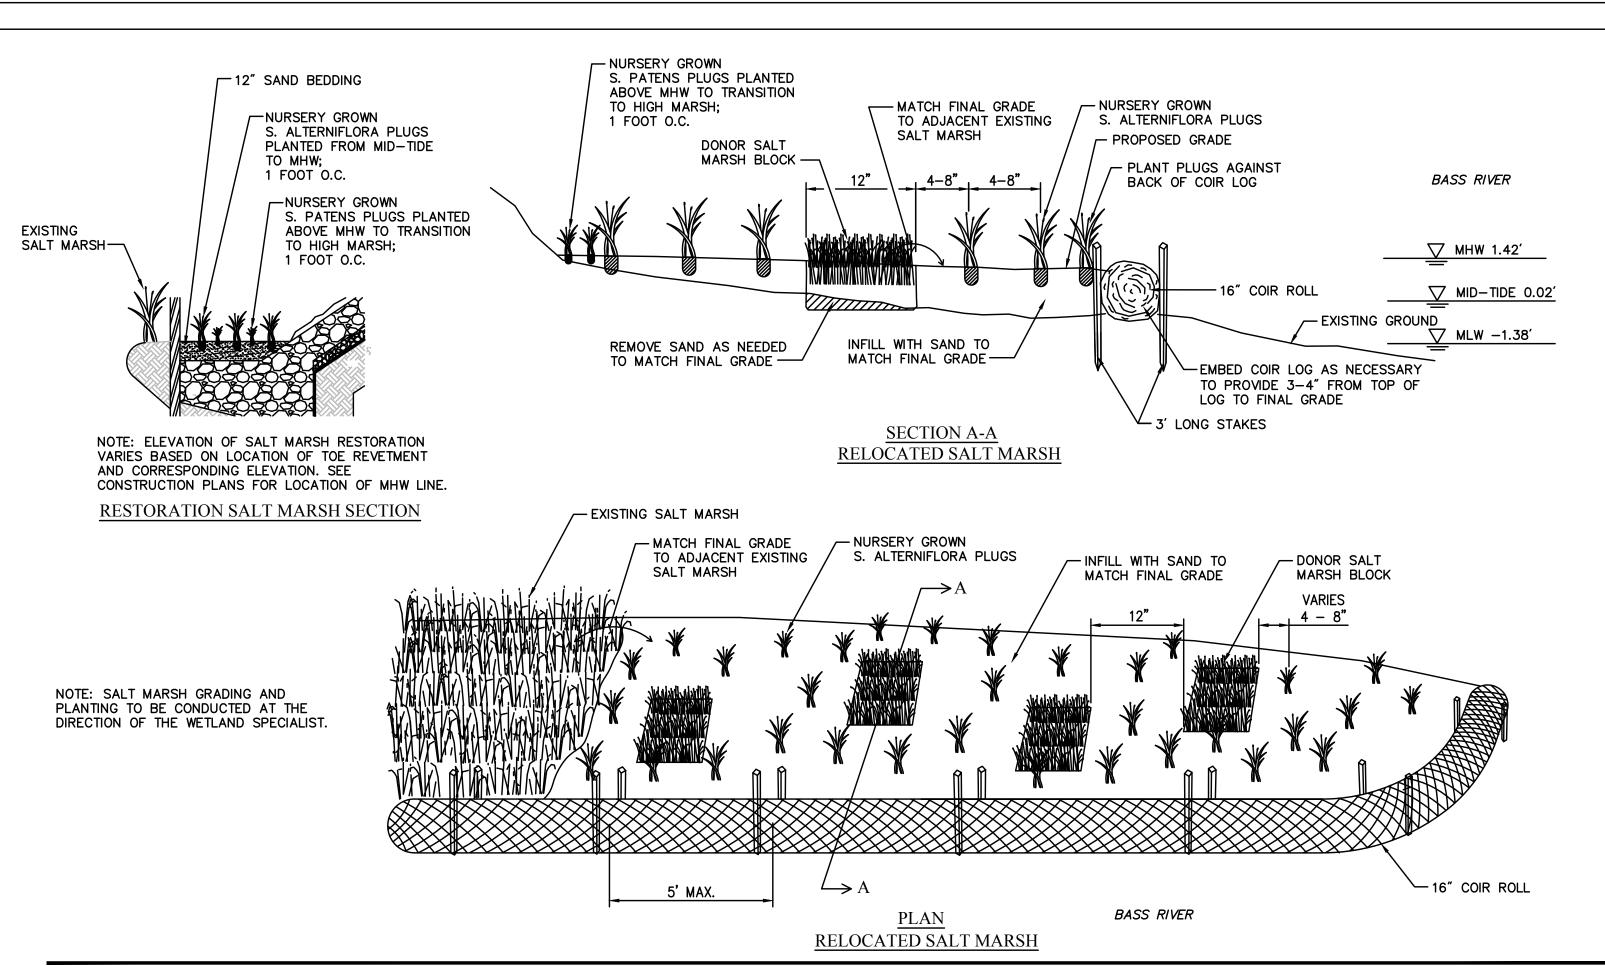


SALT MARSH MITIGATION PLAN


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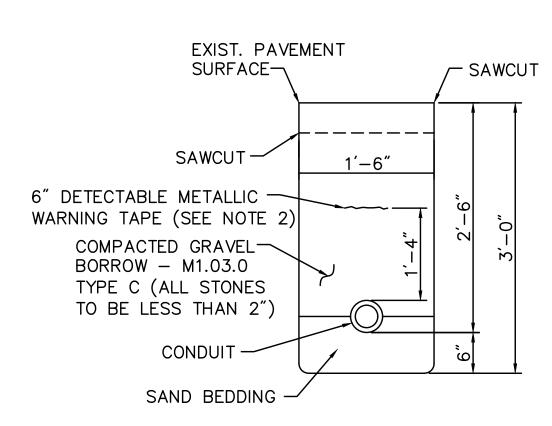


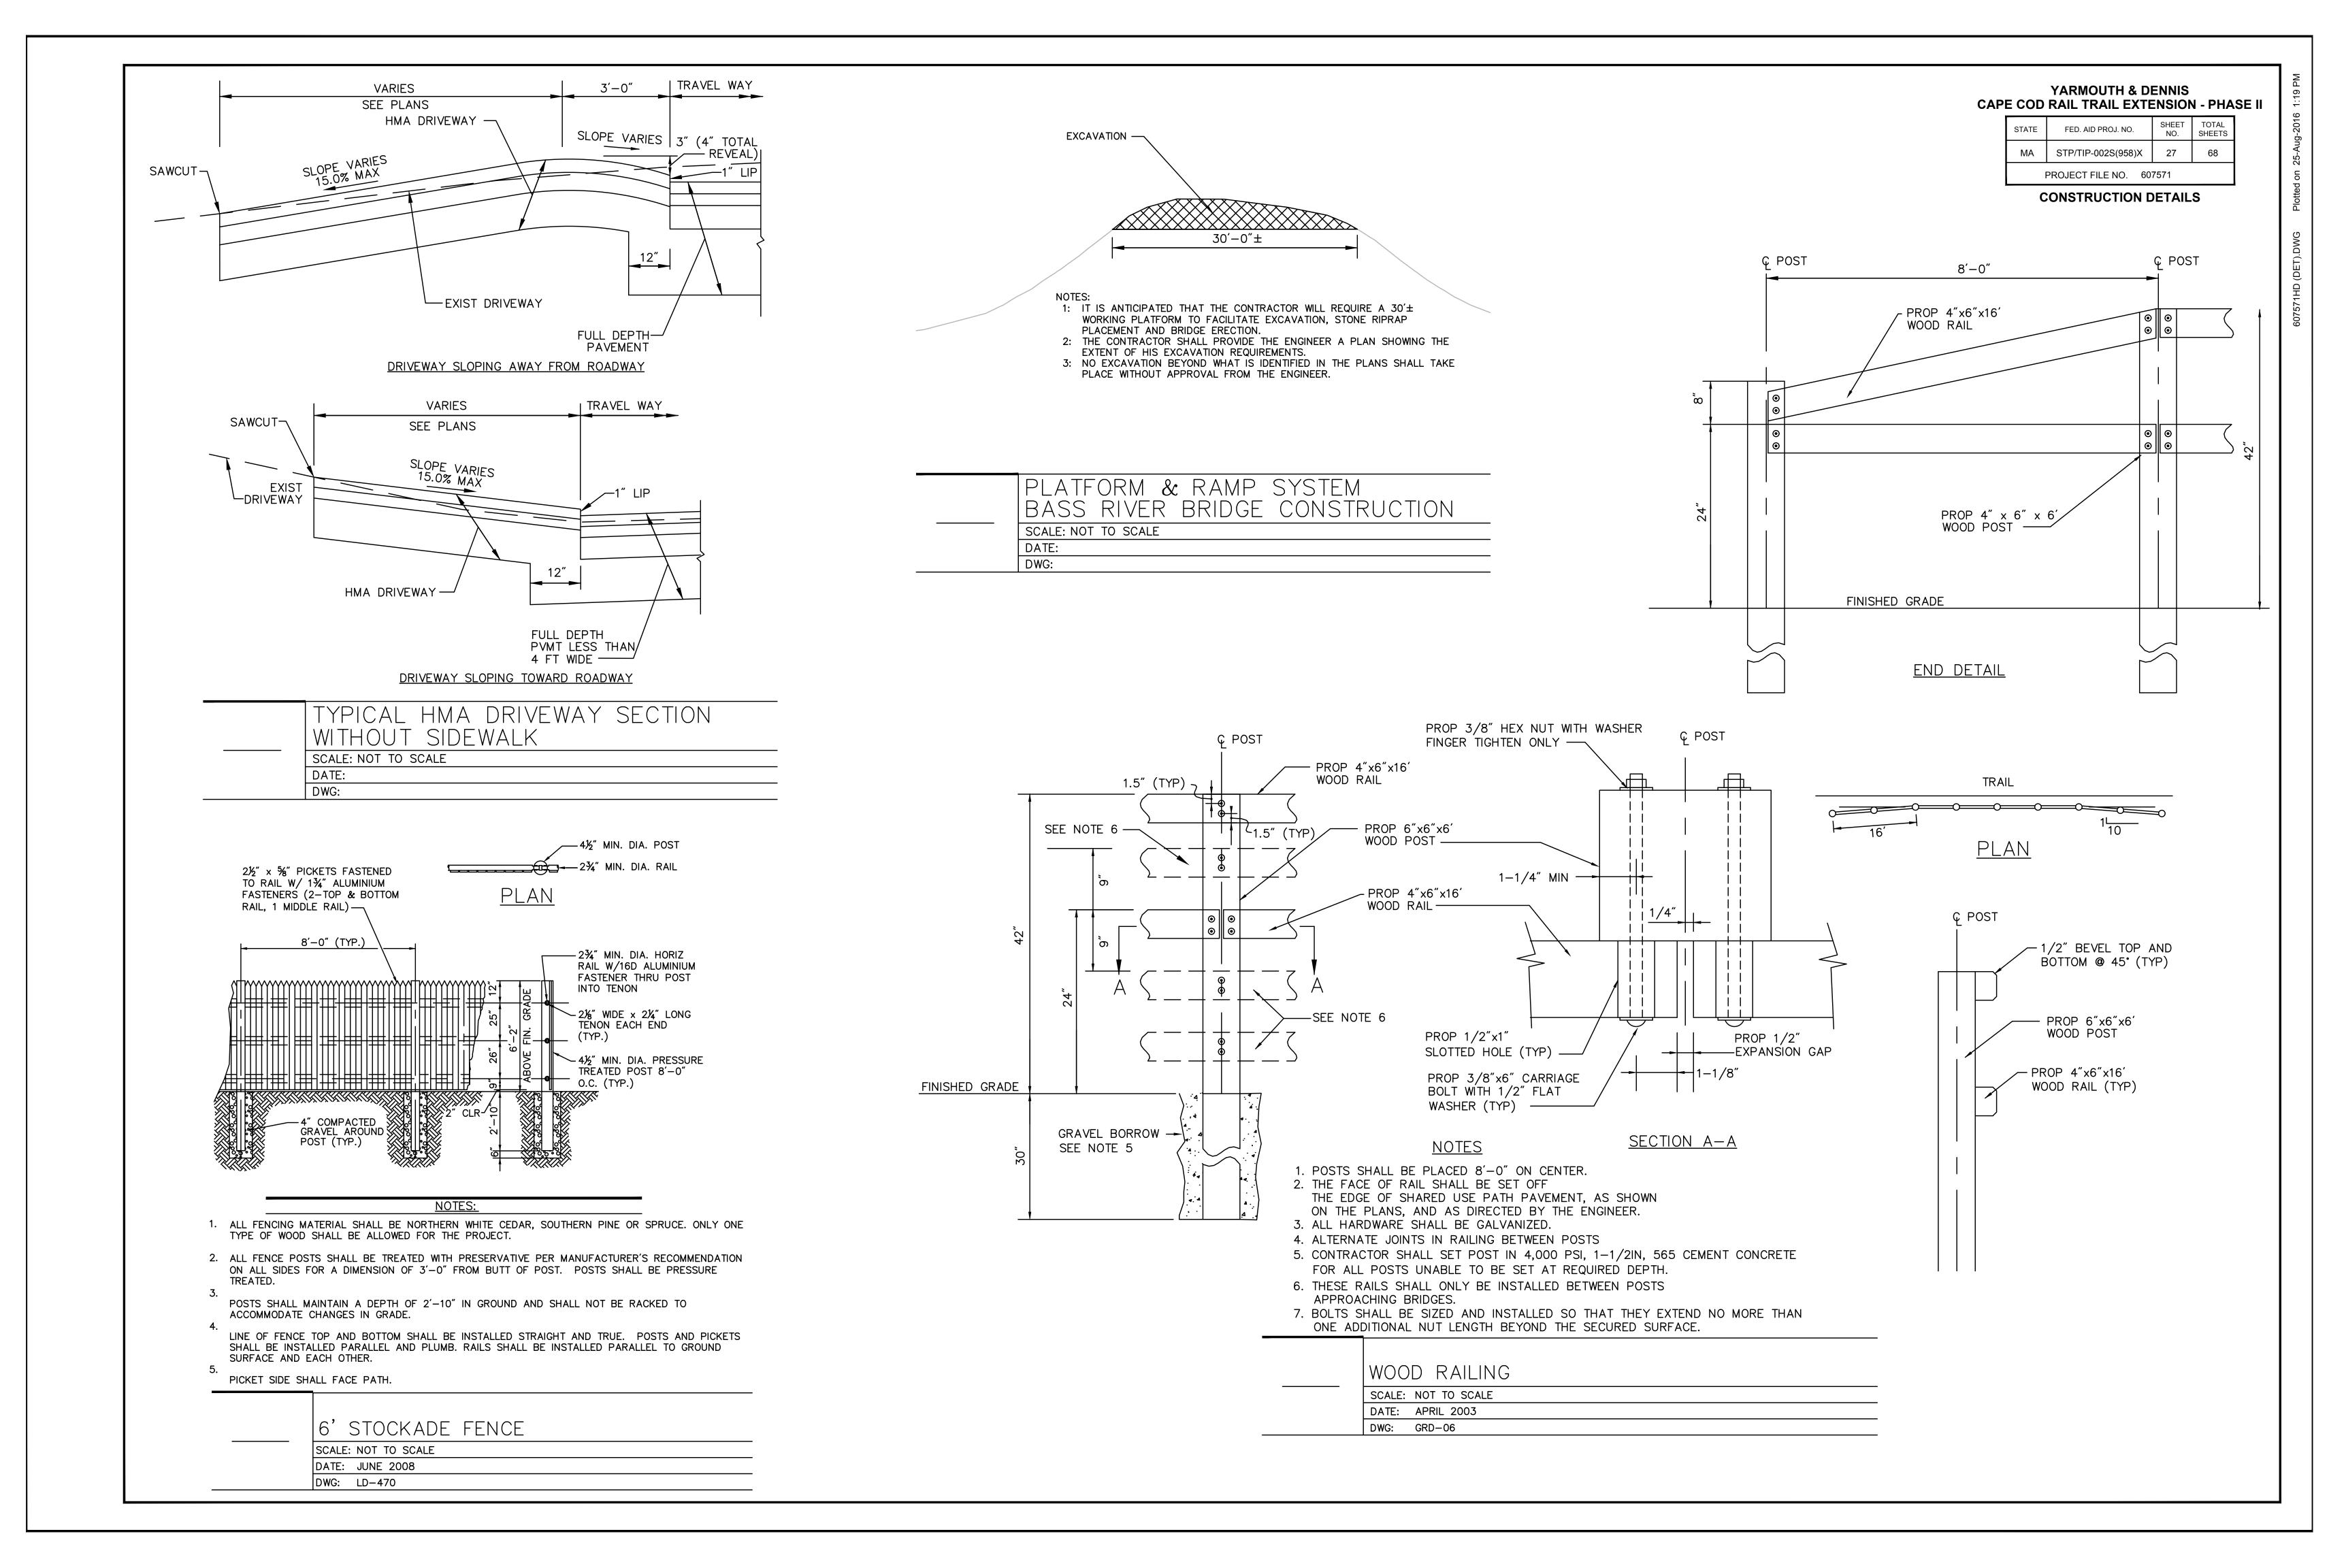- 1. SCHEDULE 80 ELECTRICAL CONDUIT TYPE NM-PLASTIC (UL.), WITH PULL ROPE, UNLESS OTHERWISE APPORVED BY MASSDOT.
- 2. CONTROL DENSITY FILL SHALL MEET THE REQUIREMENTS OF SUBSECTION M4.08.0
- 3. WARNING TAPE SHALL BE PER CURRENT APWA STANDARDS.

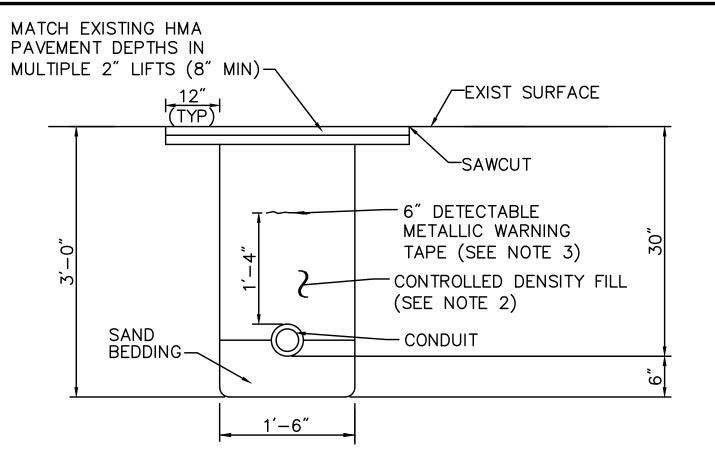

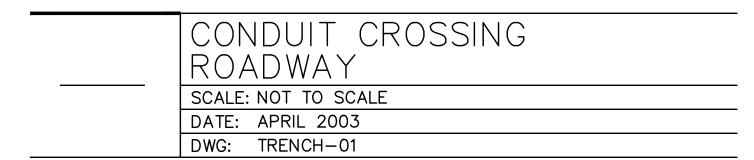


- 1. SCHEDULE 80 ELECTRICAL CONDUIT NM-PLASTIC (UL), WITH PULL ROPE, UNLESS OTHERWISE APPROVED BY MASSDOT.
- 2. WARNING TAPE SHALL BE PER CURRENT APWA STANDARD.

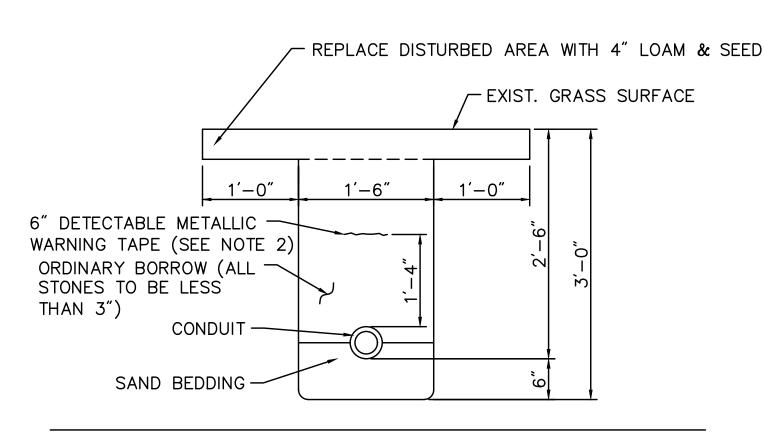

- 1. SCHEDULE 80 ELECTRICAL CONDUIT NM-PLASTIC (UL), WITH PULL ROPE, UNLESS OTHERWISE APPROVED BY MASSDOT.
- 2. WARNING TAPE SHALL BE PER CURRENT APWA STANDARD.

CONDUIT UNDER SIDEWALK/GRASS AREAS
 SCALE: NOT TO SCALE
DATE: —
DWG: -

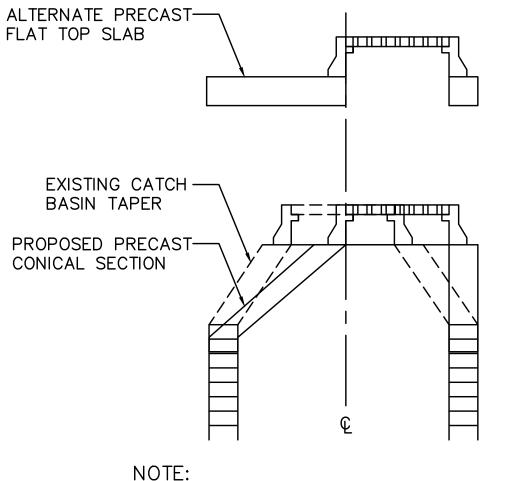

NOTE: BASED ON ACTUAL FIELD CONDITIONS; THE CONTRACTORS SHALL DETERMINE WHICH STYLE OF TOP SECTION SHOULD BE USED.

48" DIA. (MIN)

4 4 4

HOOD-

INVERT

DRAINAGE STRUCTURE REMODEL


SCALE: NTS


FINISH GRADE —


SEE NOTE 4.—

(TYP.)



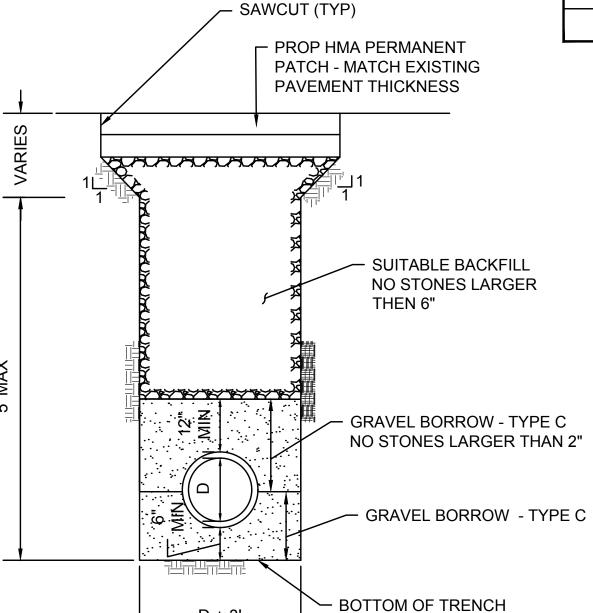

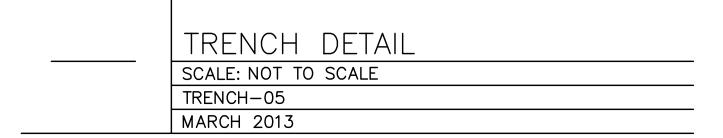

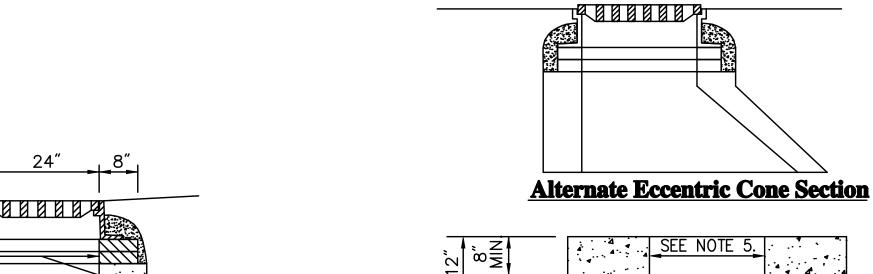

—SEE NOTE 5.

-SEE NOTE 3.

— SEE NOTE 2.

— COMPACTED

GRAVEL

— COMPACTED

SUBGRADE

OUTLET

48" DIA. (MIN.)

Alternate Top Slab

Notes:

- 1. ALL SECTIONS SHALL BE DESIGNED FOR HS-20 LOADING.
- 2. PROVIDE "V" KNOCKOUTS FOR PIPES WITH 2" MAX. CLEARANCE TO OUTSIDE OF PIPE. MORTAR ALL PIPE CONNECTIONS.
- 3. JOINT SEALANT BETWEEN PRECAST SECTIONS SHALL BE PREFORMED BUTYL RUBBER.
- 4. CATCH BASIN FRAME AND GRATE SHALL BE SET IN FULL MORTAR BED. ADJUST TO GRADE WITH CLAY BRICK AND MORTAR (2 BRICK COURSES TYPICALLY, 5 BRICK COURSES MAXIMUM).
- 5. OPENING IN TOP SLAB SHALL BE 24"x27" FOR CATCH BASINS WITH CURB INLETS. OPENING SHALL BE 24"x24" AT ALL OTHER LOCATIONS.


CATCH BASIN SCALE: NOT TO SCALE DATE: 10-28-2008 DWG: -

VARIES

YARMOUTH & DENNIS **CAPE COD RAIL TRAIL EXTENSION - PHASE II**


TOTAL SHEETS FED. AID PROJ. NO. STP/TIP-002S(958)X

CONSTRUCTION DETAILS

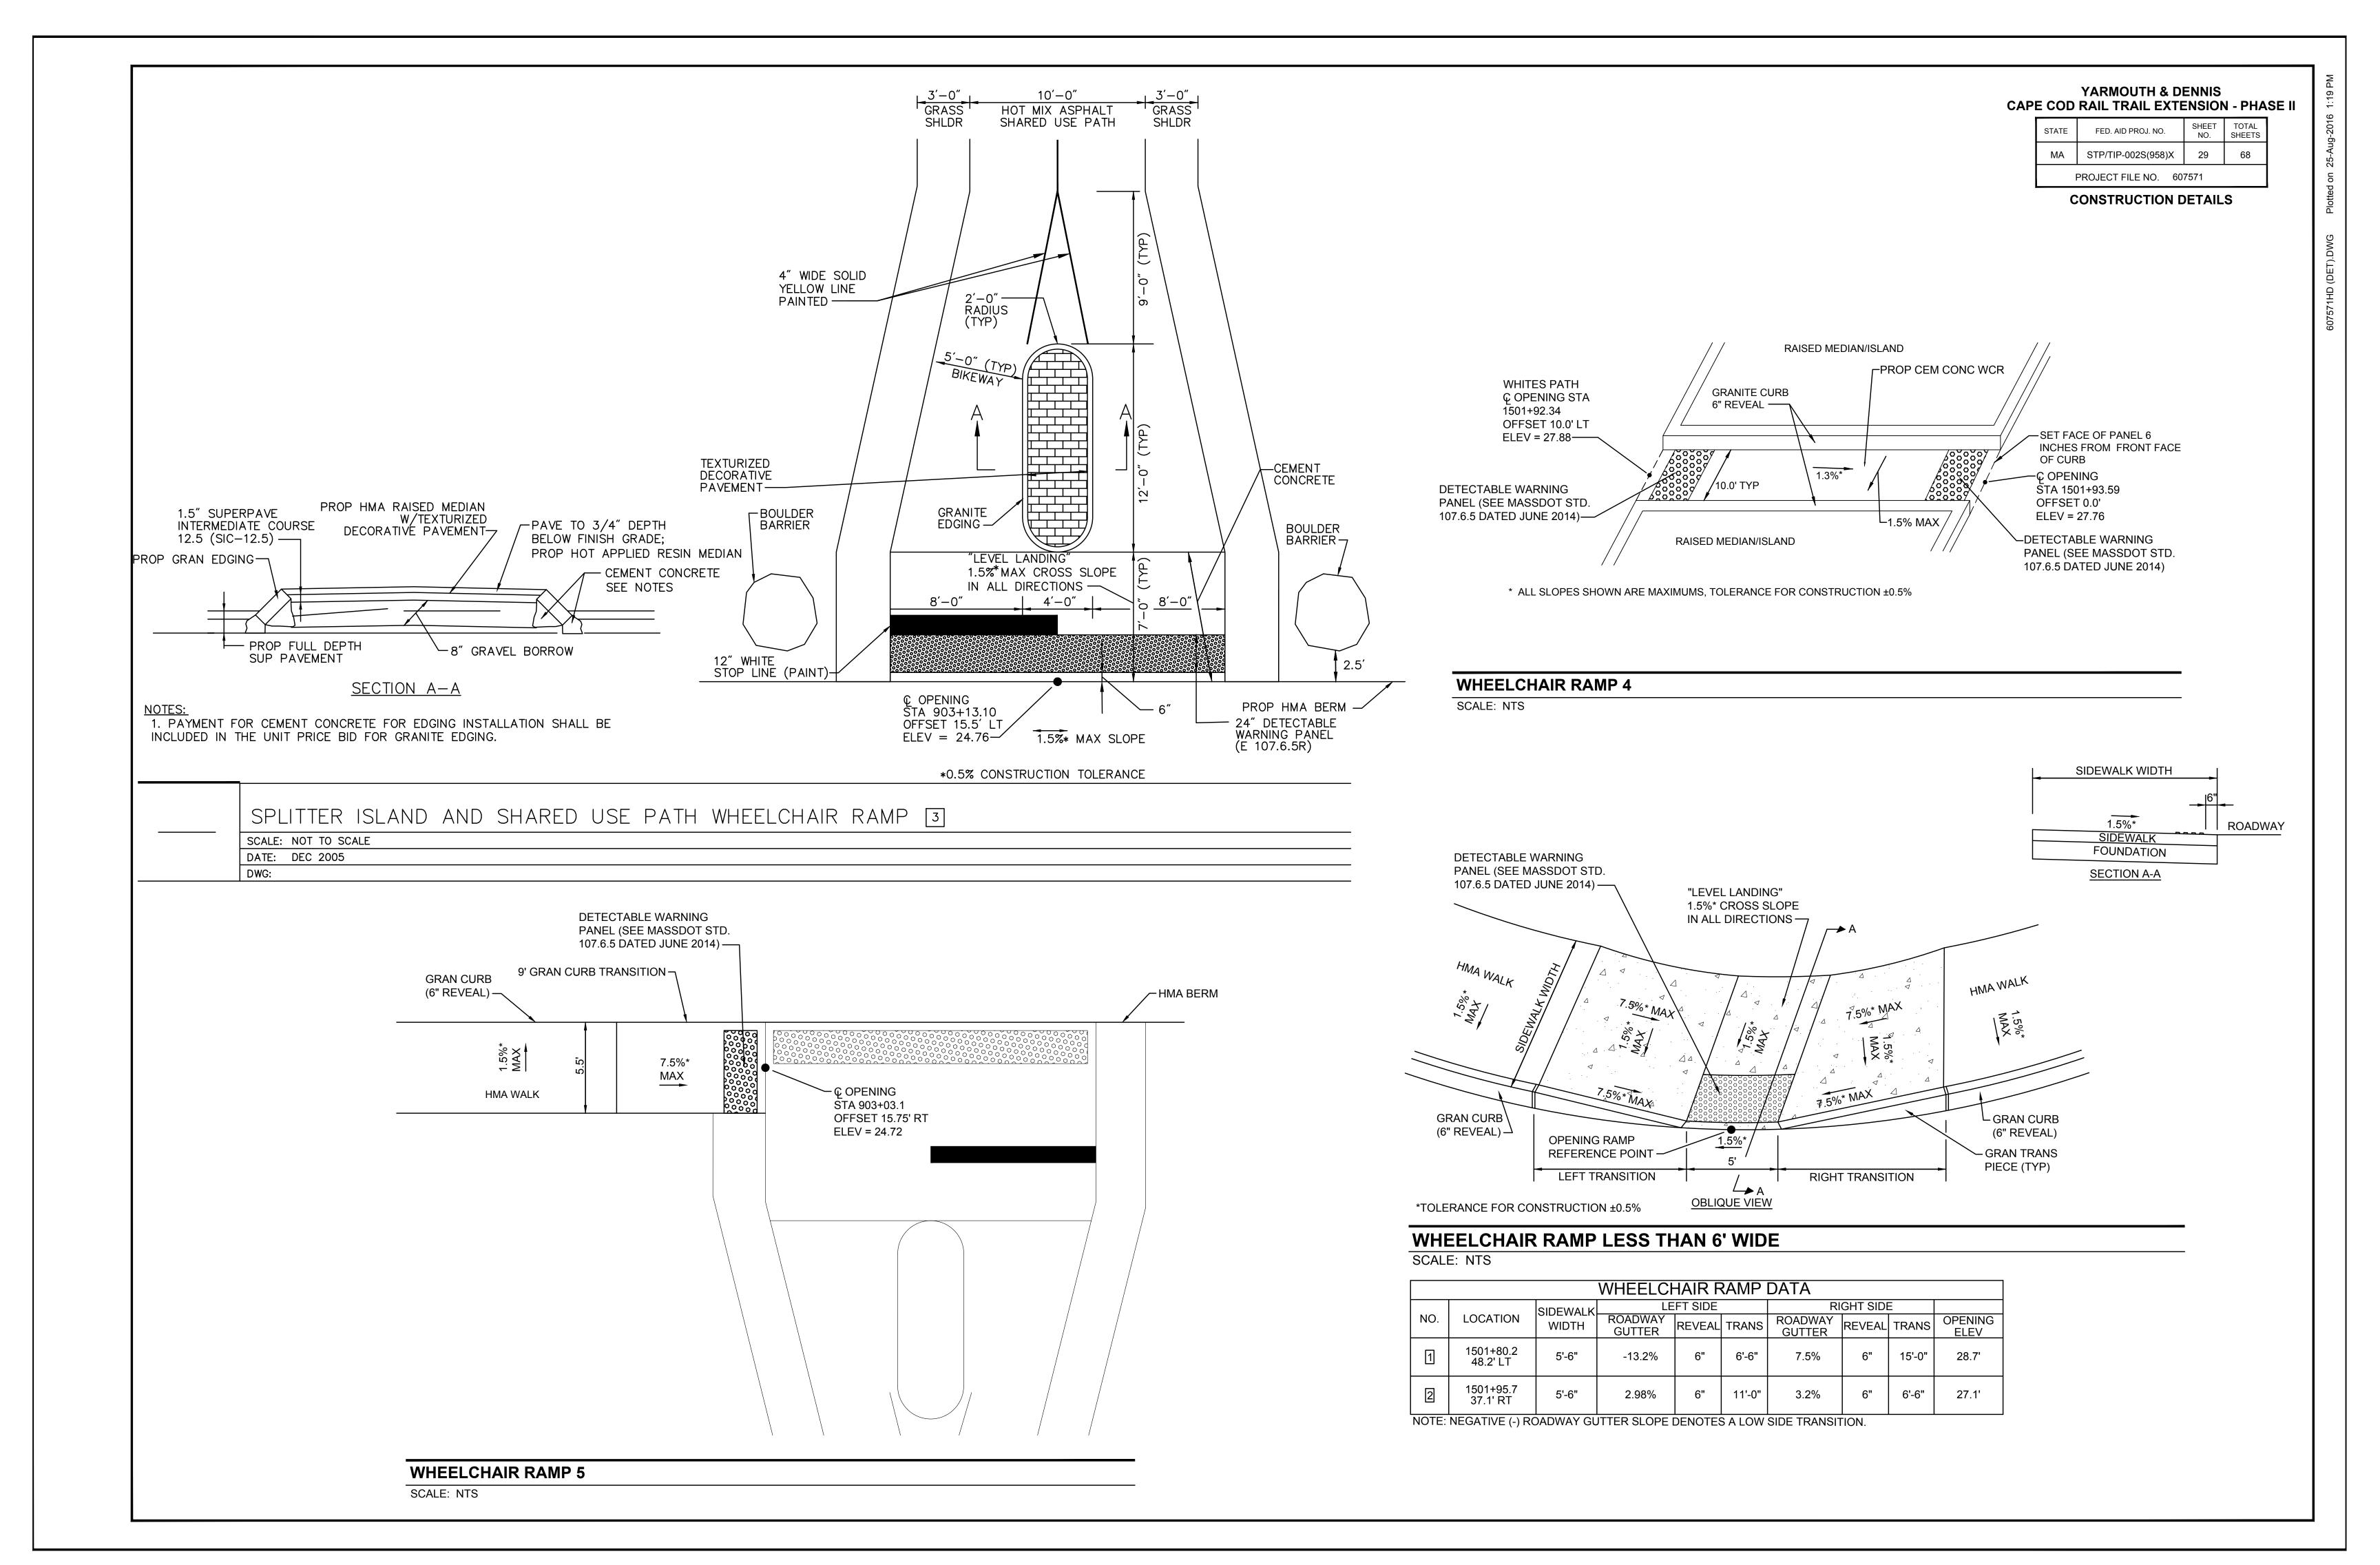

ATE	FED. AID PROJ. NO.	SHEET NO.	TOTAL SHEETS
1A	STP/TIP-002S(958)X	30	68
PROJECT FILE NO 607571			

CONSTRUCTION DETAILS

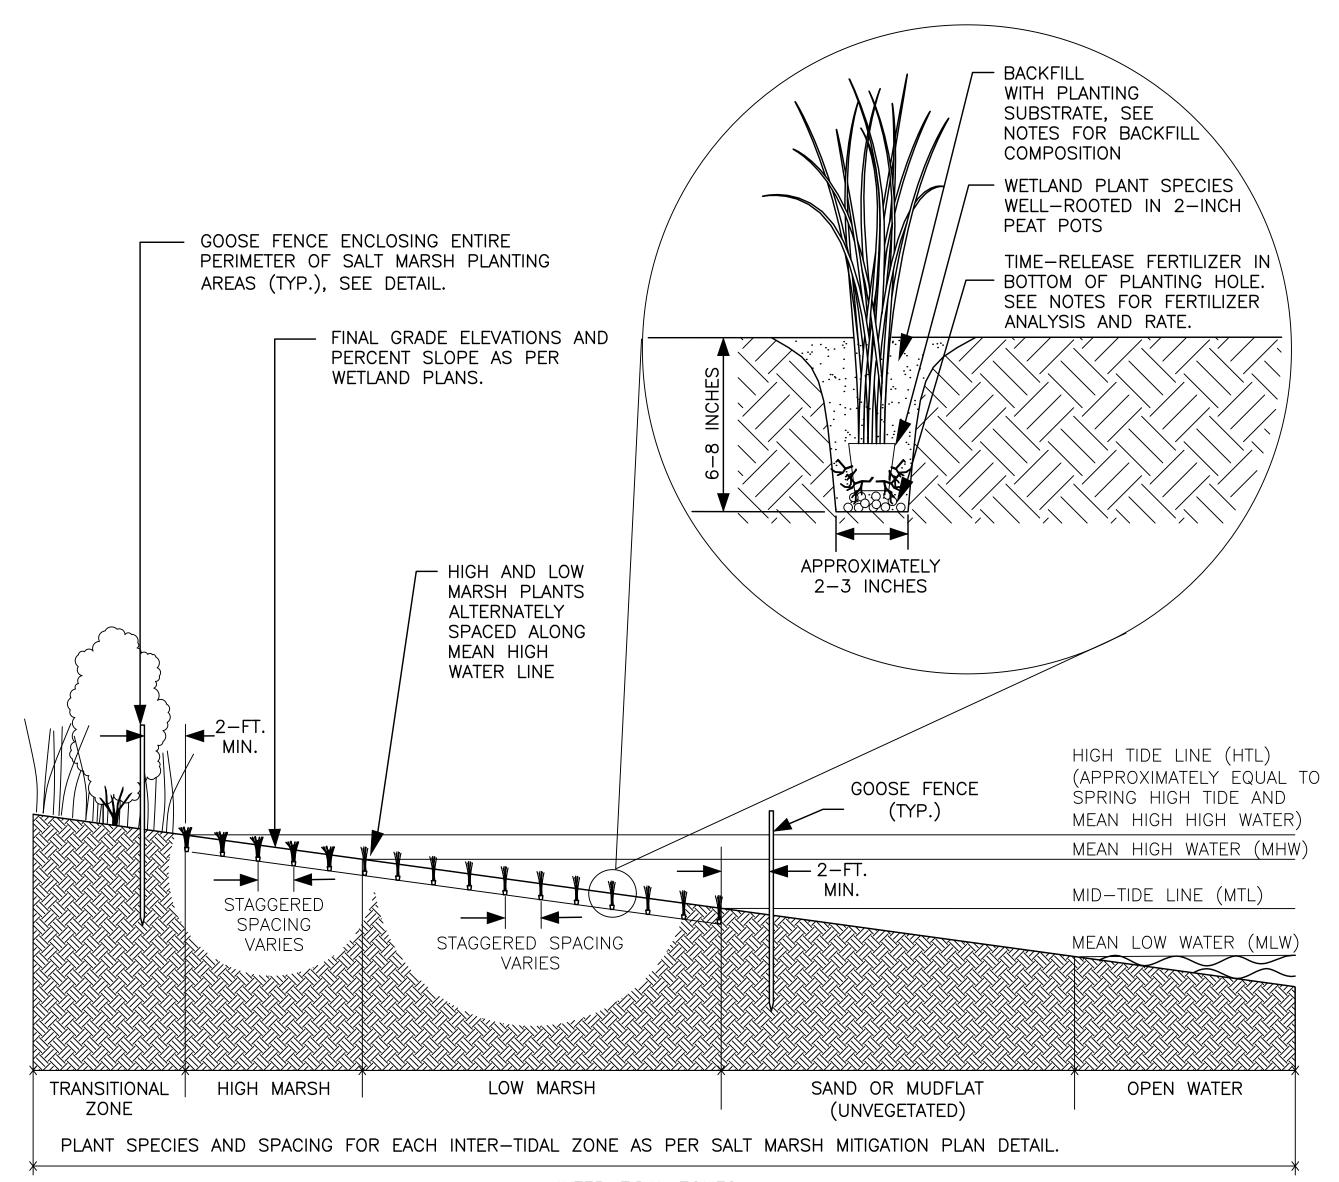


INTER-TIDAL ZONES

SECTION VIEW

NOTE: DUE TO VARIATIONS IN SURFACE AND GROUNDWATER SALINITY, BOUNDARIES OF PLANT COMMUNITIES MAY NOT BE STRICTLY DEFINED BY INTER—TIDAL ZONE ELEVATIONS.


TYPICAL TIDAL WETLAND PLANTING

SCALE: NTS

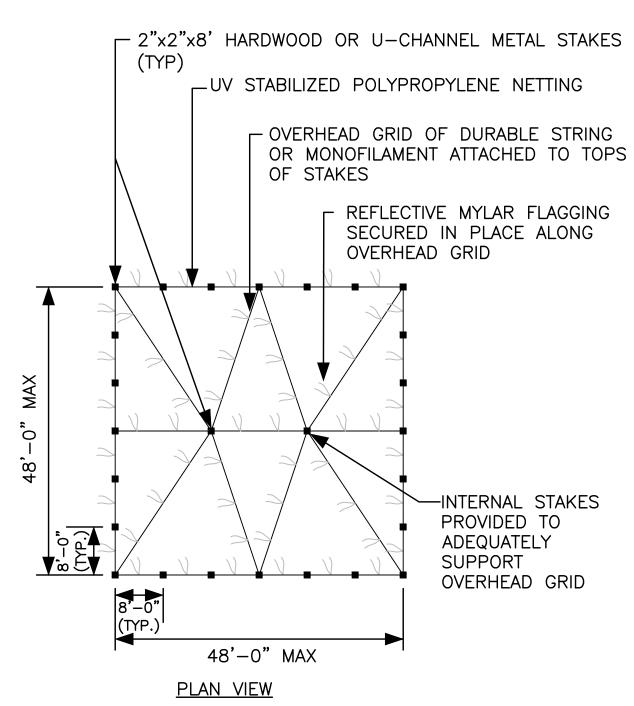


NOTE: ACTUAL SIZE AND SHAPE OF CELLS WILL BE DETERMINED BY PLANTING AREA. FENCING SHALL ENCLOSE ALL WETLAND PLANTINGS AND INCLUDE A 1 TO 2 FT. MARGIN AROUND PERIMETER OF PLANTS.


FOR LARGE SITES, IT IS RECOMMENDED THAT 2.5 - 3 FT. WIDE, UNPLANTED ACCESS AISLES BE PROVIDED BETWEEN EVERY OTHER CELL FOR ACCESS DURING MONITORING PERIOD.

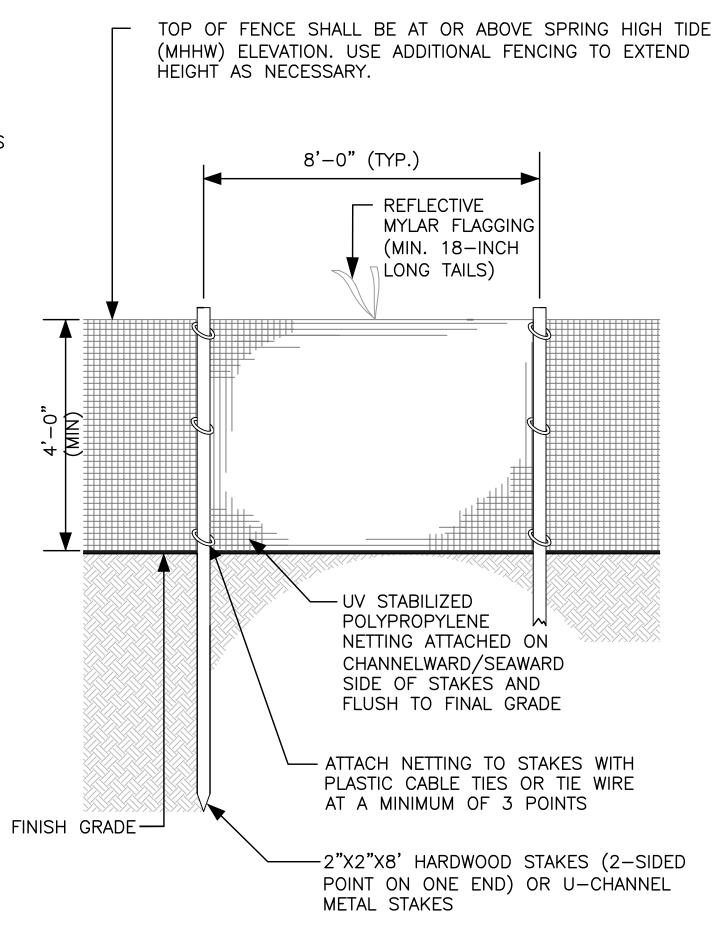

TYPICAL GOOSE FENCE

SCALE: NTS

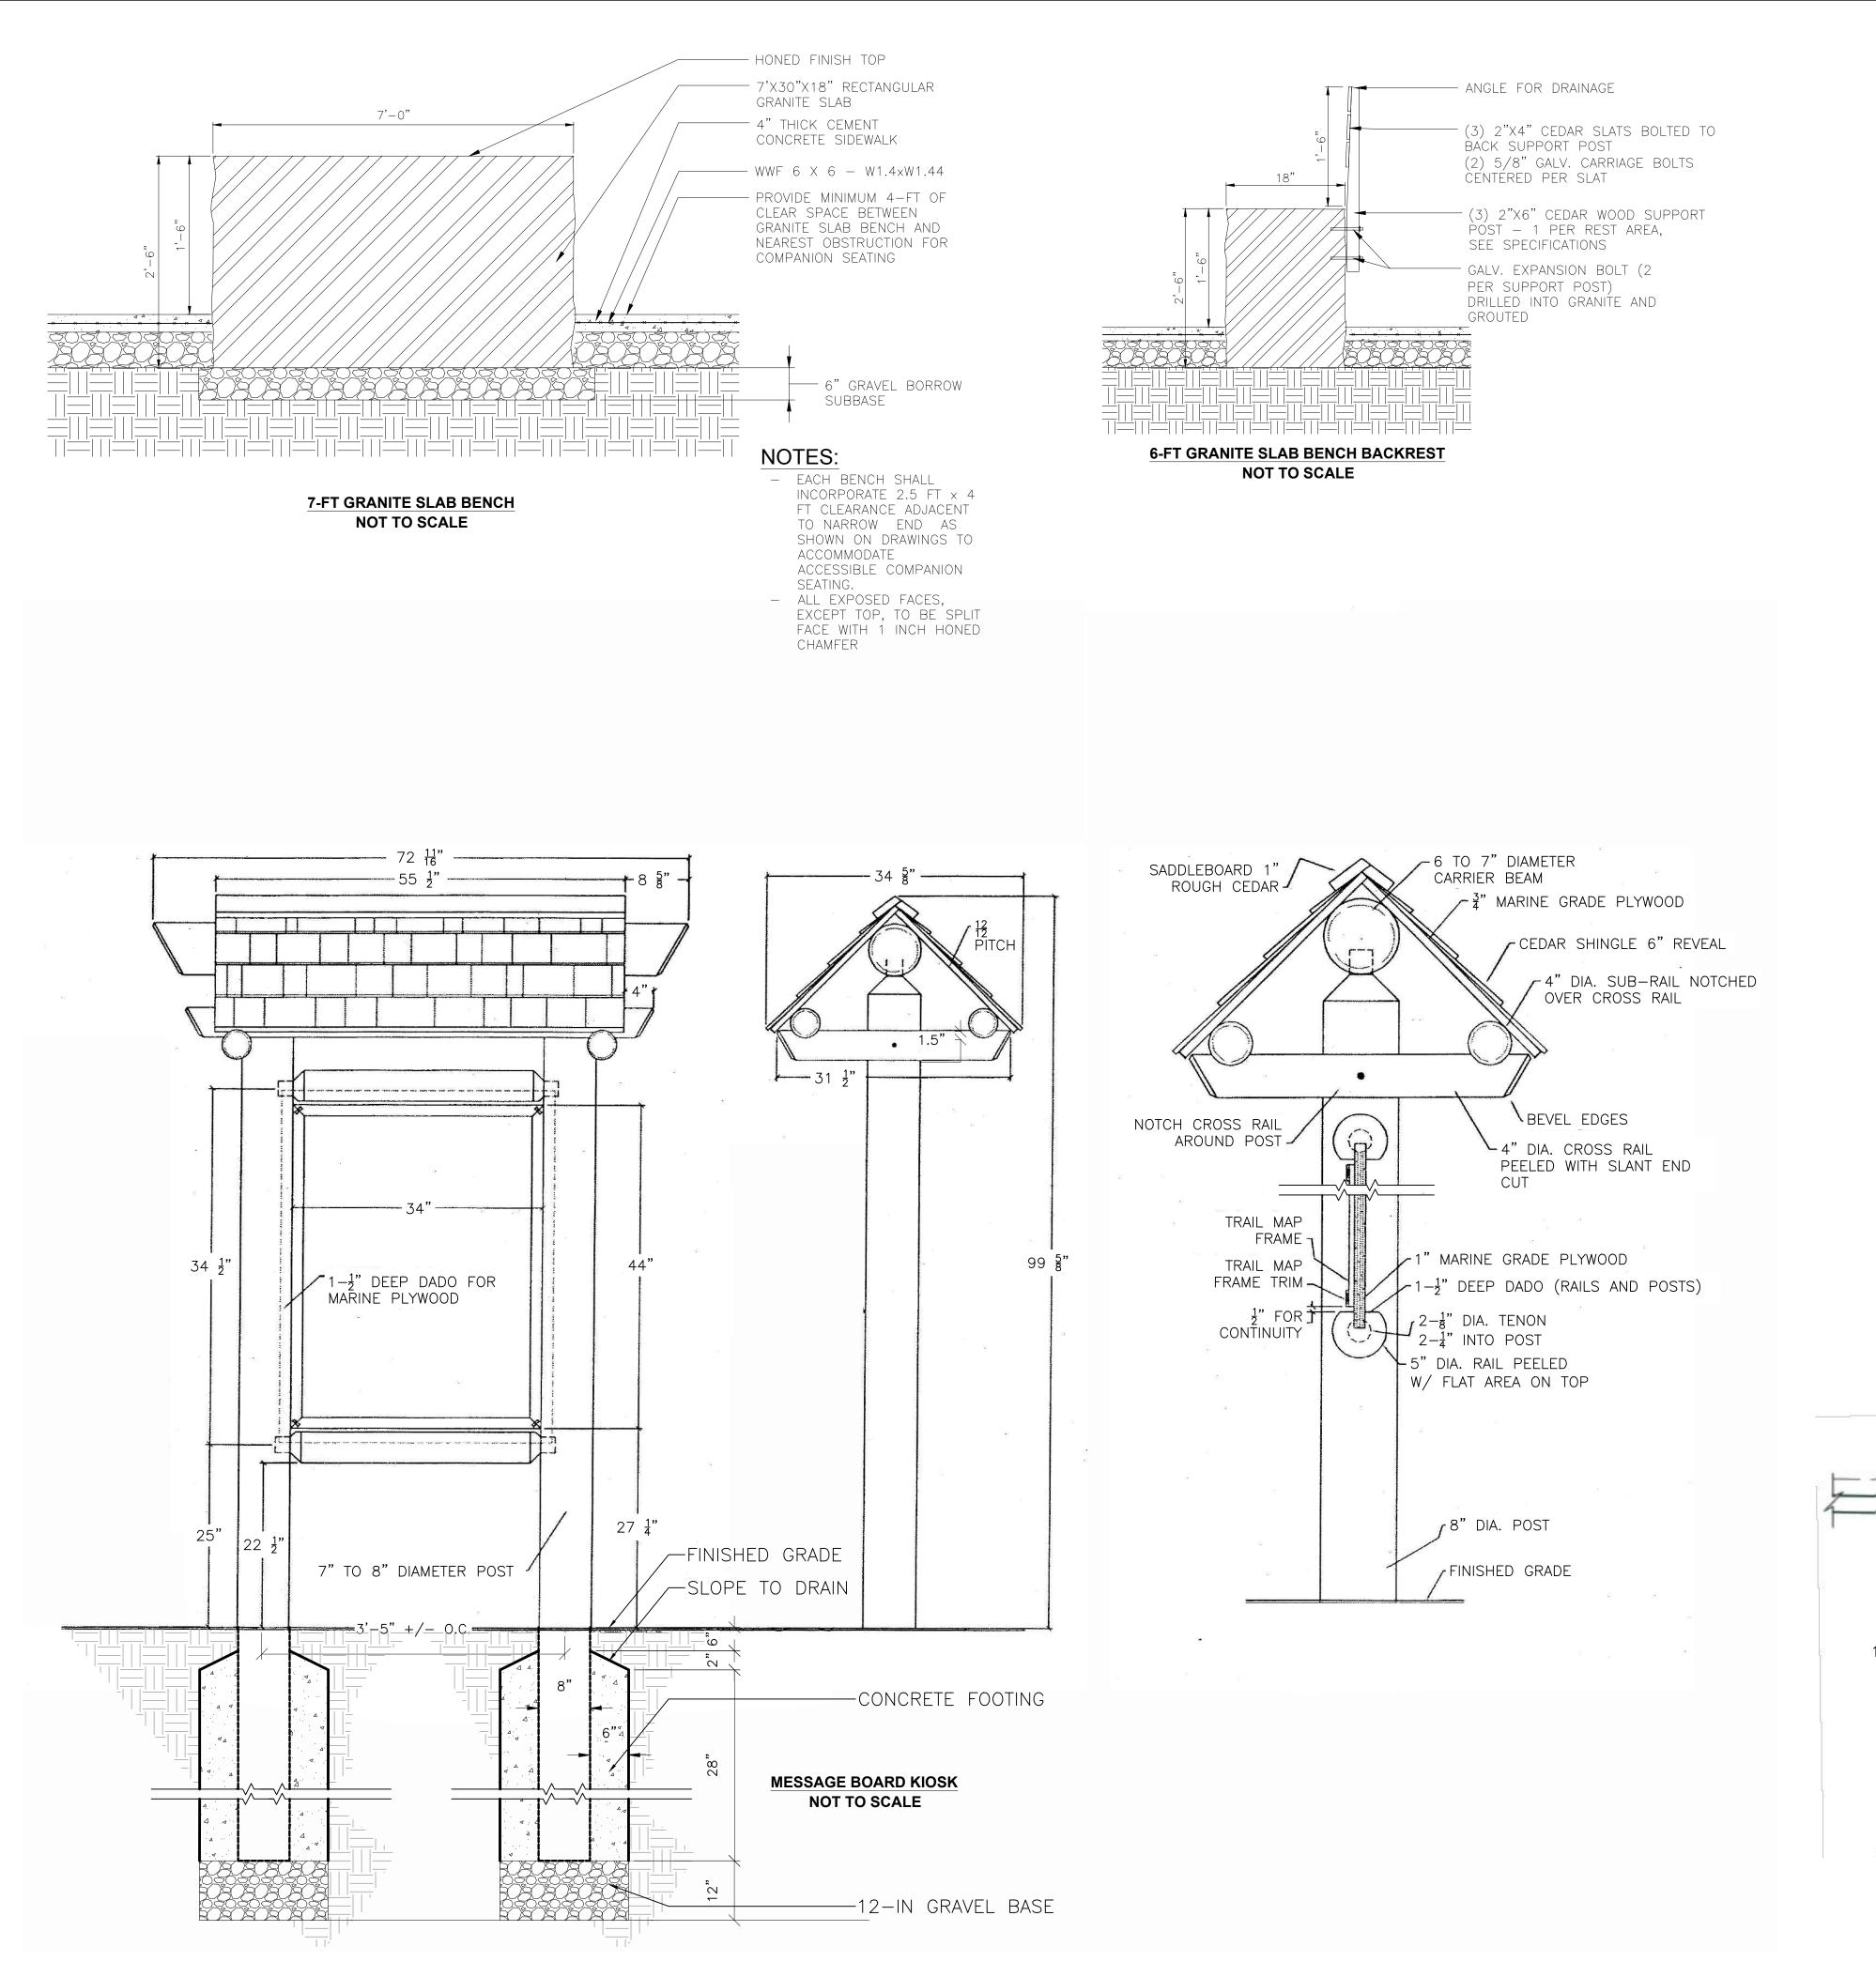

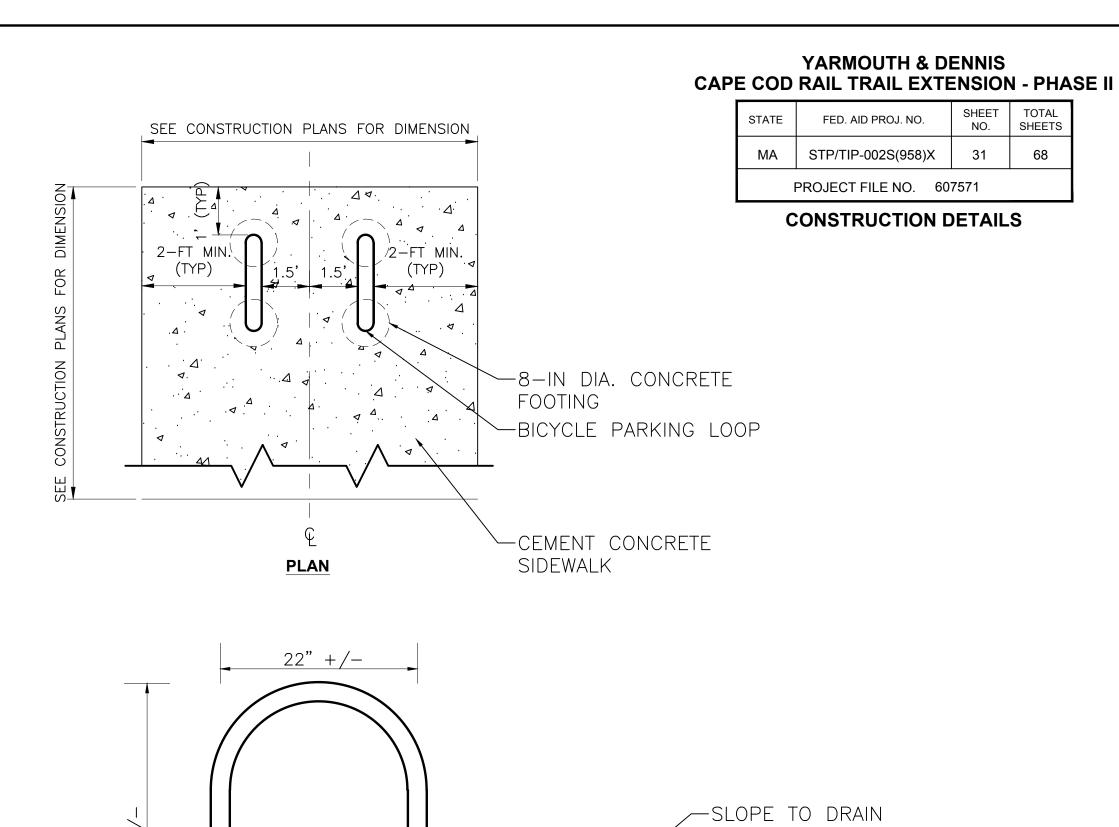

-1" DIA X 6" LONG

PIPE (TYP.)

—FINISHED GRADE

GRAVEL BORROW

STEEL DOWEL THROUGH

-CEMENT CONCRETE SIDEWALK

NOTES:


1. BICYCLE RACK UNITS SHALL CONSIST OF INVERTED "U" PIPES

2. 2IN NOM SCHED 40, ASTMA 500 WELDED SEAMLESS STEEL PIPE CONSTRUCTION


3. INVERTED "U" PIPES SHALL BE PLACED PARALLEL TO EACH OTHER 36-INCHES O.C.

4. CONCRETE SHALL BE 4000 PSI, 3/4IN, 565 CEMENT CONCRETE

U-SHAPED BICYCLE RACK NOT TO SCALE

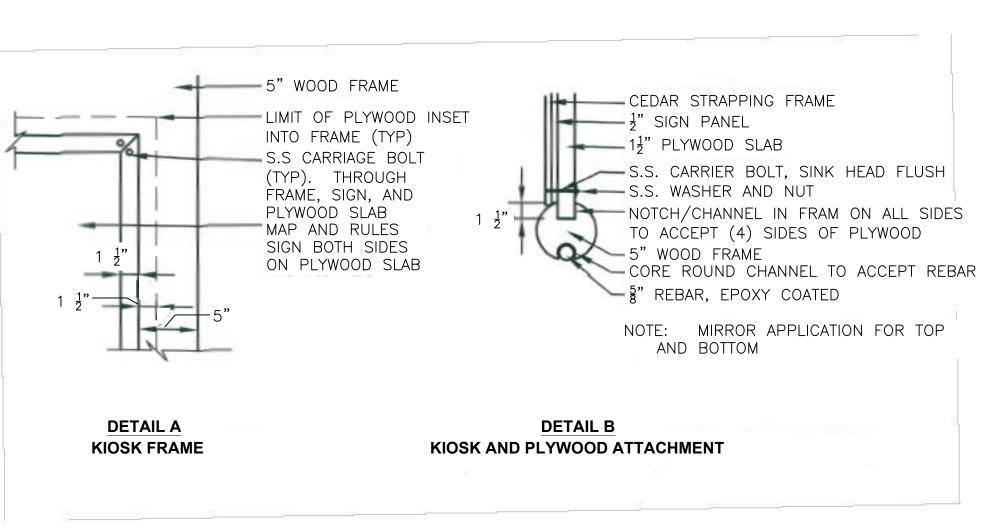

NOTE: MESSAGE BOARD MAP SIGN TO BE PRINTED DOUBLE SIDED

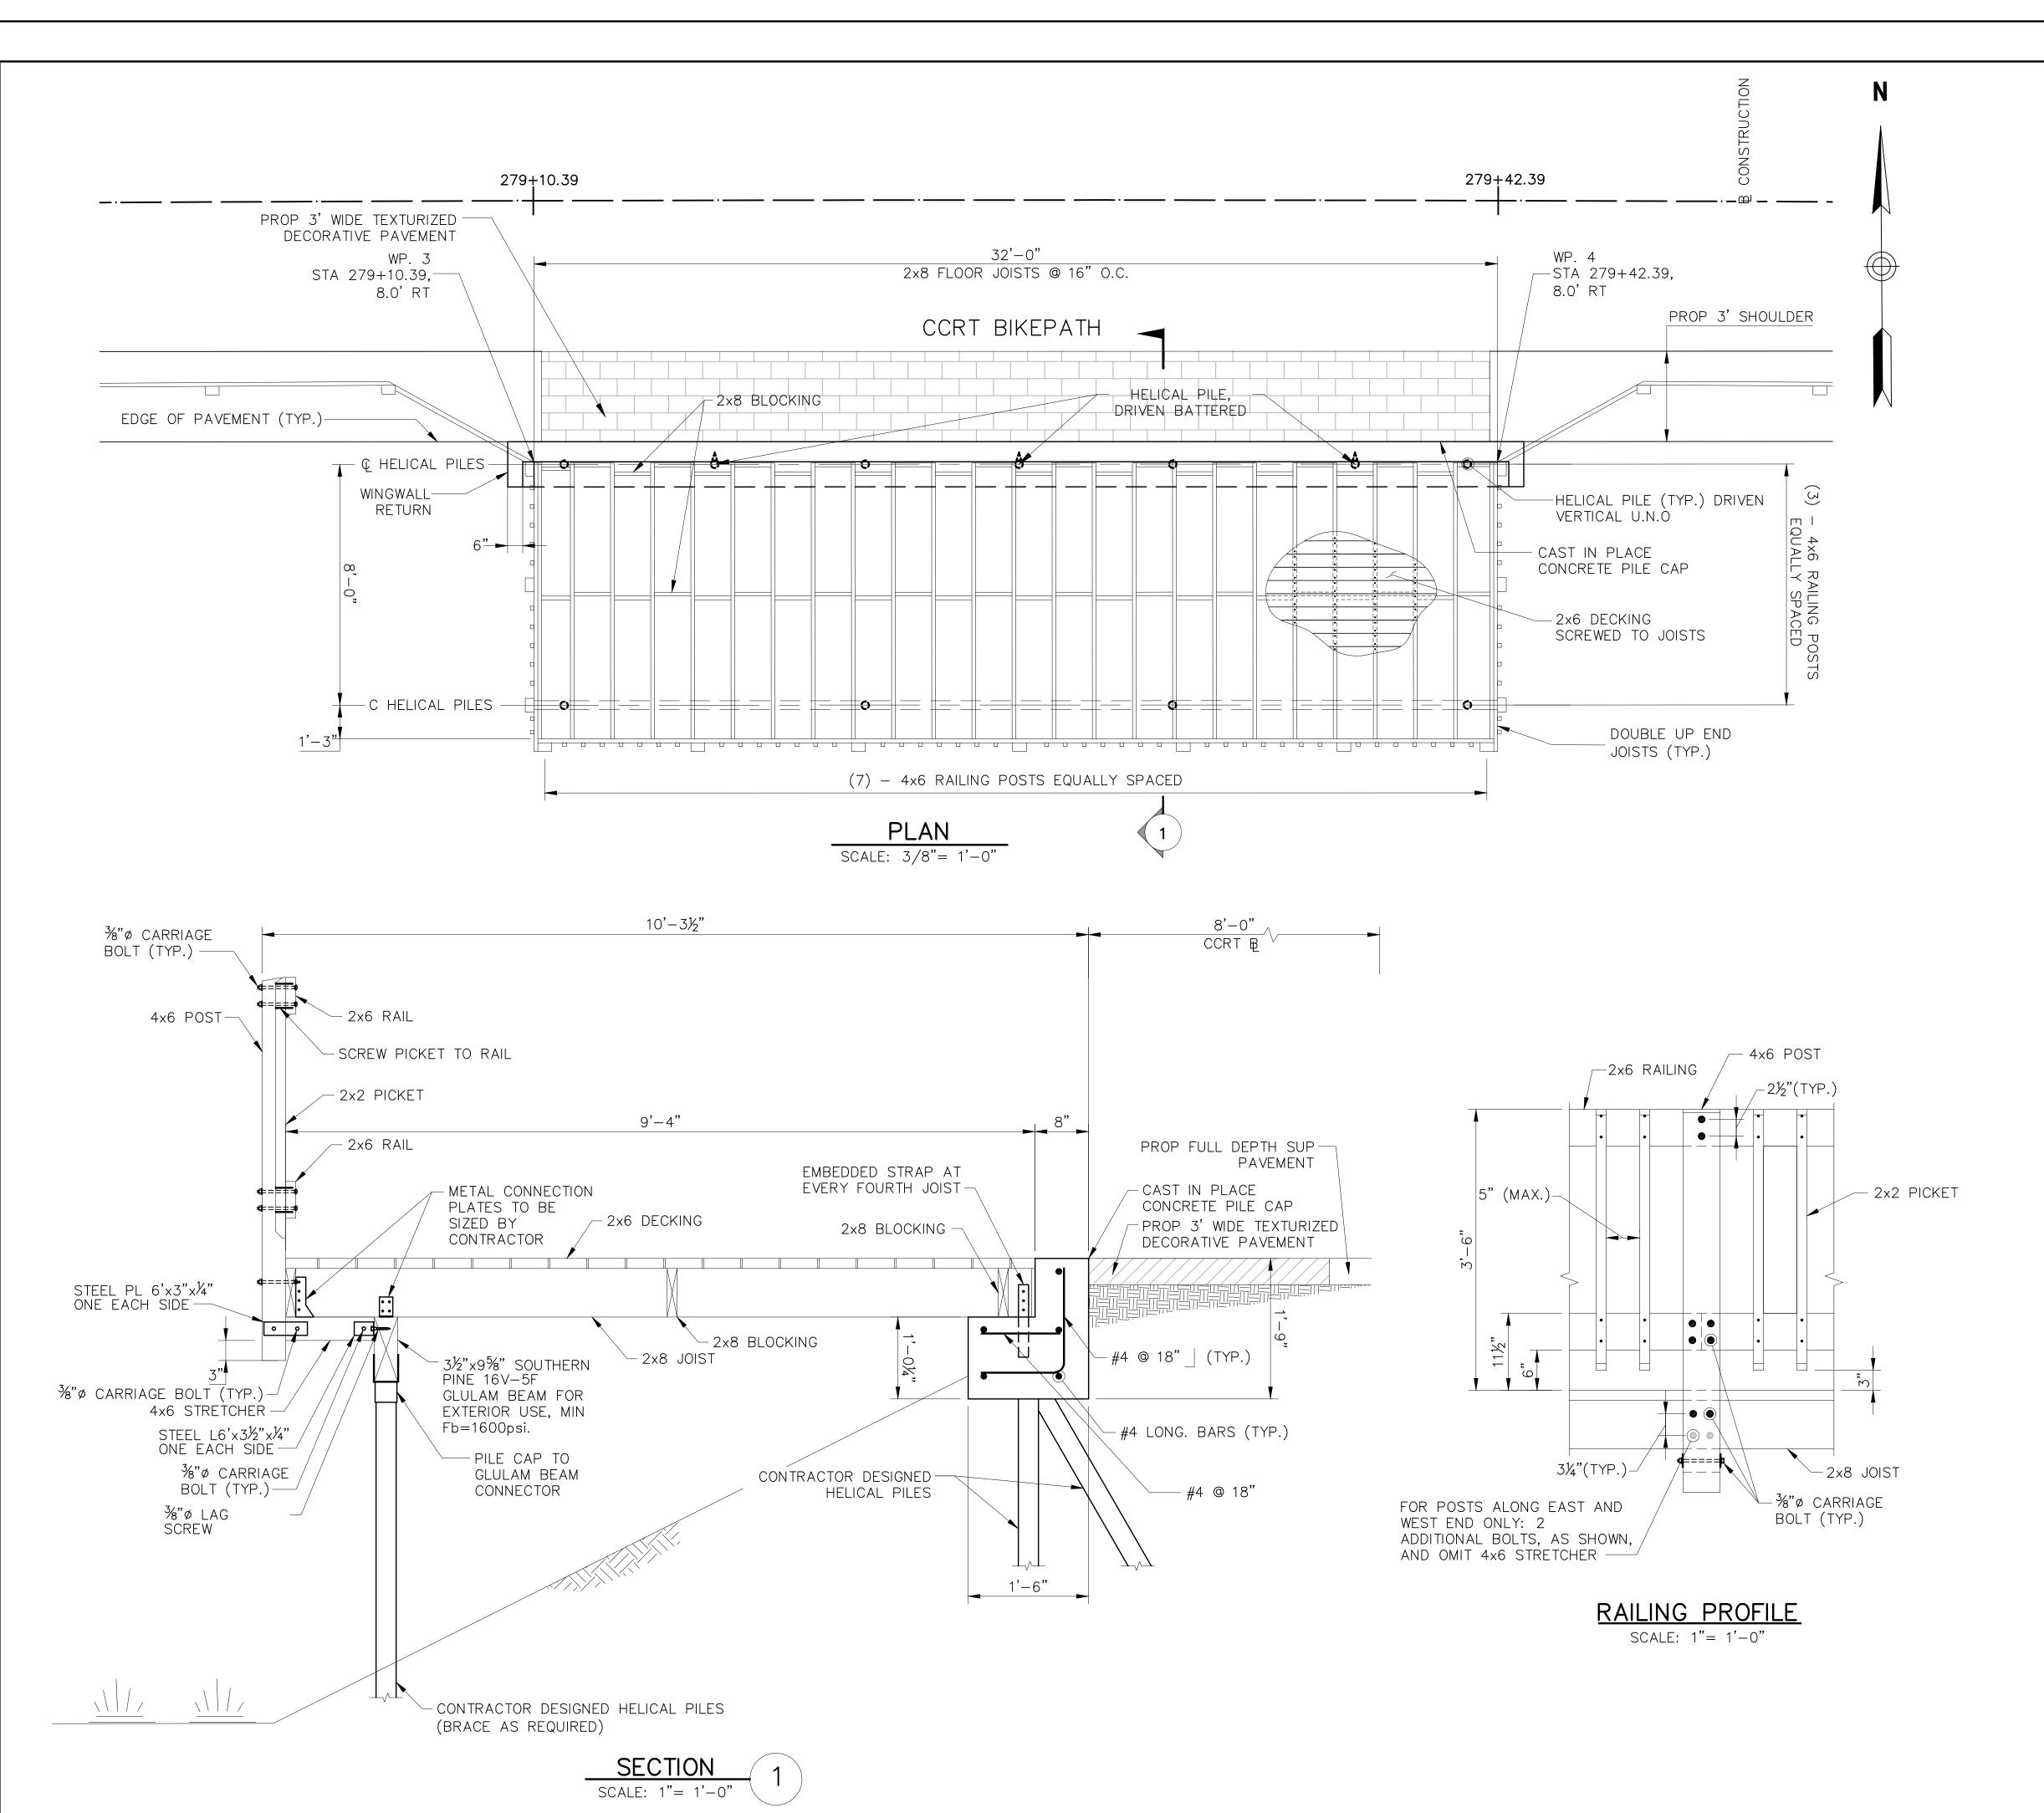

YARMOUTH & DENNIS CAPE COD RAIL TRAIL EXTENSION - PHASE II

STATE	FED. AID PROJ. NO.	SHEET NO.	TOTAL SHEETS	
MA	STP/TIP-002S(958)X	32	68	
PROJECT FILE NO. 607571				


CONSTRUCTION DETAILS - OVERLOOK

NOTES:

- 1. ALL METAL HARDWARE, INCLUDING BOLTS, SCREWS, NAILS, ANGLES, STRAPS, STEEL PLATES AND JOIST HANGERS SHALL BE STAINLESS STEEL.
- 2. TIMBER SIZES SHOWN ON THIS PLAN ARE NOMINAL, EXCEPT FOR GLULAM BEAM.
- 3. ALL TIMBER SHALL BE PRESSURE TREADED WITH ALKALINE COPPER QUAT (ACQ), CONFORMING TO AWPA STANDARDS.
- 4. ALL TIMBER SHALL BE SOUTHERN PINE NO. 1 DENSE, Fb=2000PSI, EXCEPT BLOCKING WHICH MAY BE NO. 2.
- 5. RAILS TO SPAN A MINIMUM OF 3 POSTS.
- 6. PILOT HOLES SHALL BE DRILLED PRIOR TO DRIVING OF SCREWS.
- 7. BOLT HOLES SHALL BE PRE DRILLED TO A DIAMETER 1/6" LARGER THAN BOLT DIAMETER.
- 8. ALL HOLES SHALL BE TREATED THOROUGHLY PRIOR TO INSTALLING SCREWS OR BOLTS.
- 9. CEMENT CONCRETE MASONRY SHALL BE 4000PSI $-\frac{3}{4}$ " 610#.

REINFORCING STEEL SHALL BE ASTM A615, GRADE 60 EPOXY COATED.

- 10. MINIMUM CLEAR COVER FOR REINFORCING SHALL BE 3" FOR CONCRETE CAST AGAINST AND PERMANENTLY EXPOSED TO EARTH
- 11. AND 2" FOR ALL OTHER LOCATIONS.
- 12. CONTRACTOR SHALL BE RESPONSIBLE FOR THE DESIGN OF THE HELICAL PILES, INCLUDING THE CONNECTIONS BETWEEN THE HELICAL PILES AND THE CONCRETE PILE CAP AND GLULAM BEAM, AND LATERAL BRACING FOR PILES.
- 13. CONTRACTOR SHALL SUBMIT TO THE ENGINEER, ALL NECESSARY CALCULATIONS AND DETAILS FOR REVIEW AND APPROVAL, PRIOR TO CONSTRUCTION.
- 14. HELICAL PILE AND CONNECTION DESIGNS SHALL BE IN ACCORDANCE WITH THE MASSDOT BRIDGE DESIGN MANUAL AND AASHTO STANDARD SPECIFICATIONS FOR HIGHWAY BRIDGES, CURRENT ED., AND SHALL BE DESIGNED FOR SERVICE LOADS 8.0 KIPS VERTICAL FORCE PER PILE TO BE CARRIED BY VERTICAL PILES, AND SERVICE LOADS 5.0 KIPS LATERAL FORCE PER PILE TO BE CARRIED BY THE BATTERED PILES.
- 15. MINIMUM NUMBER OF VERTICAL PILES EQUALS 8.
- 16. MINIMUM NUMBER OF BATTERED PILES EQUALS 3.
- 17. MAXIMUM SPACING BETWEEN PILES EQUALS 10'-0".

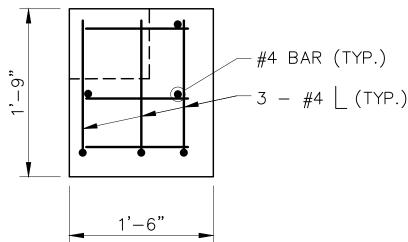

WINGWALL RETURN
REINFORCING DETAIL

SCALE: 1"= 1'-0"